




NOTE: ALL ARCHITECTURAL INFORMATION SHOWN ON PAGES 3 AND 4 OF THIS EXHIBIT WAS TAKEN FROM PAGES A-1 AND A-2 OF PLANS PREPARED BY A.V. LAKE CONSTRUCTION COMPANY IN SEPTEMBER, 2005 AND PROVIDED TO POLARIS ENGINEERING AND SURVEYING ON MAY 17, 2006.

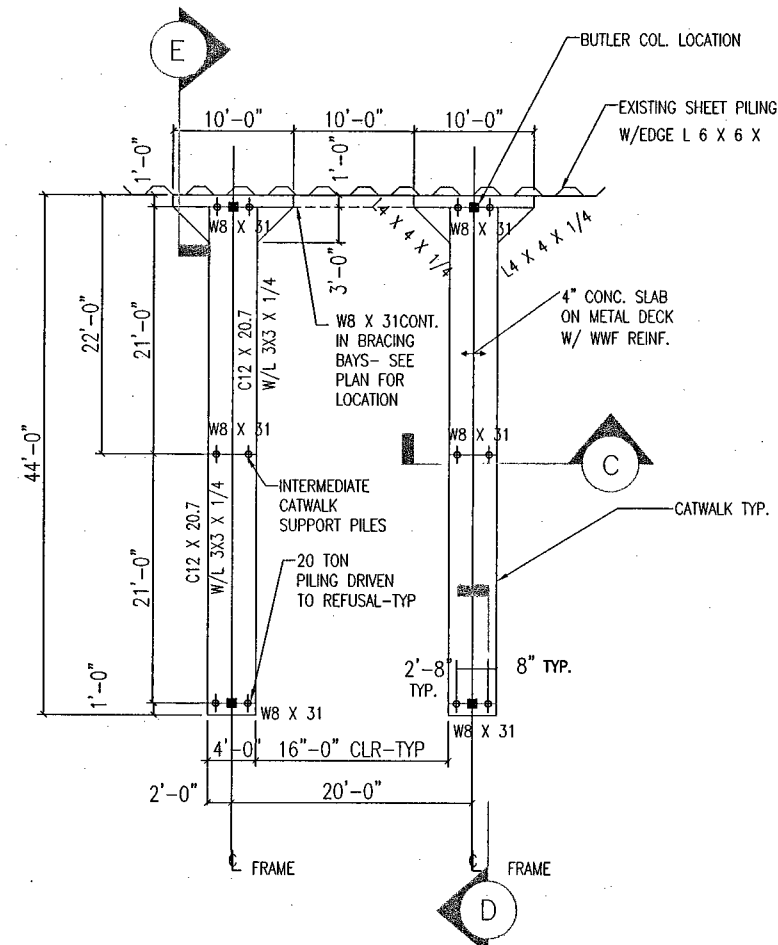


A ENLARGED FRAMING PLAN
SCALE: 3/32" = 1'-0"

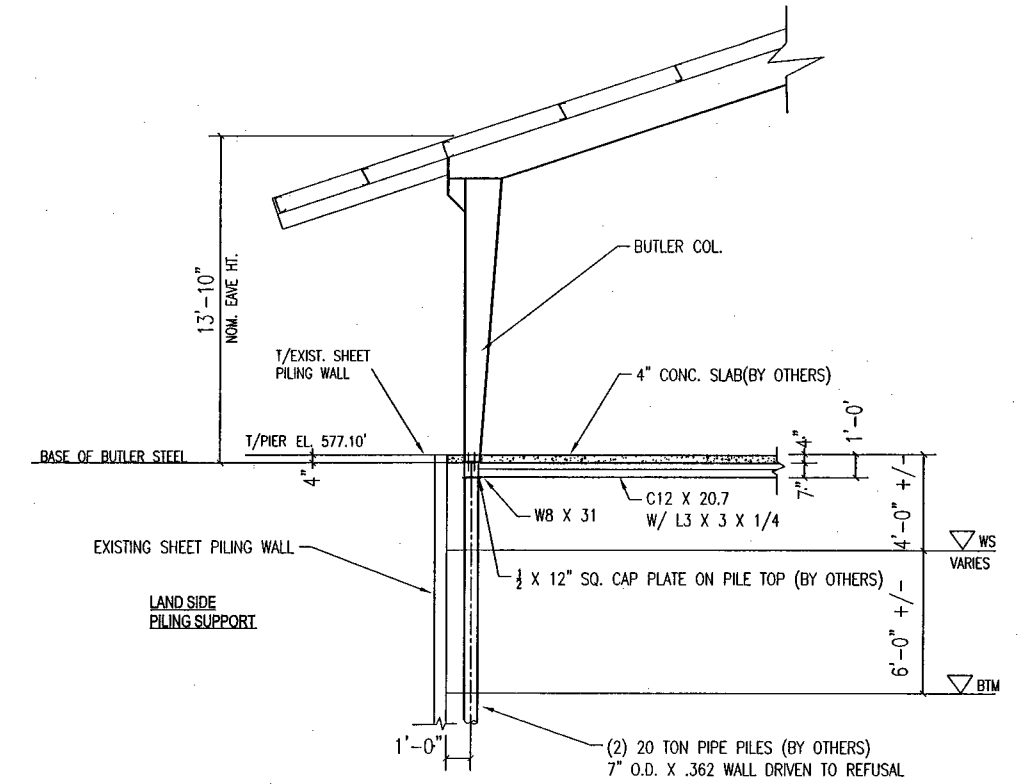


B SIDE VIEW DOCK ELEVATION
SCALE: 3/16" = 1'-0"

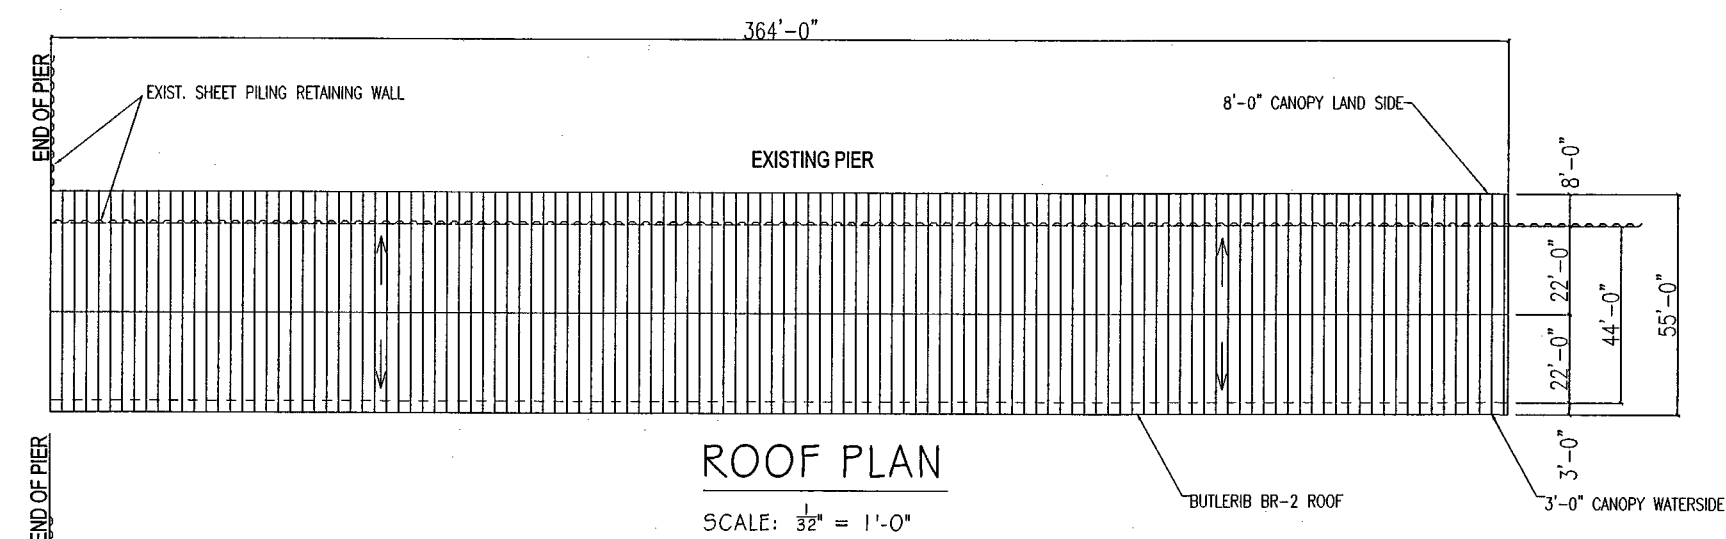


ROOF PLAN
SCALE: 1/32" = 1'-0"

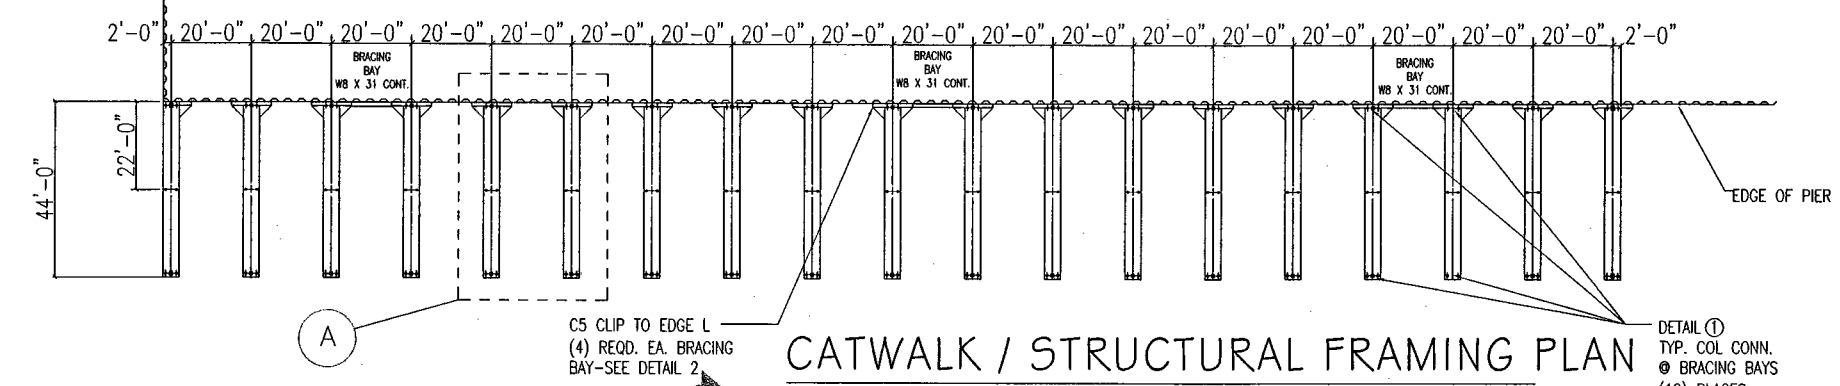


CATWALK / STRUCTURAL FRAMING PLAN
SCALE: 1/32" = 1'-0"
18 SPA @ 20' = 360'

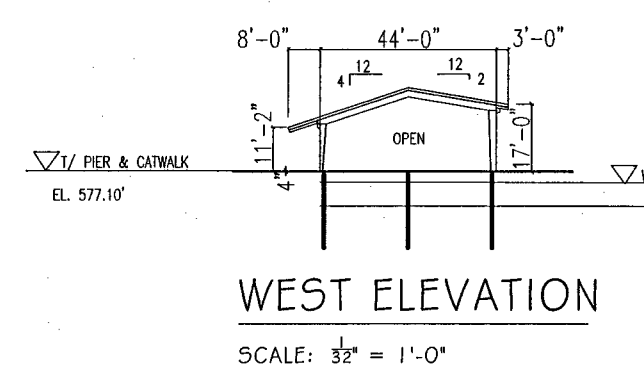

WEST ELEVATION
SCALE: 1/32" = 1'-0"

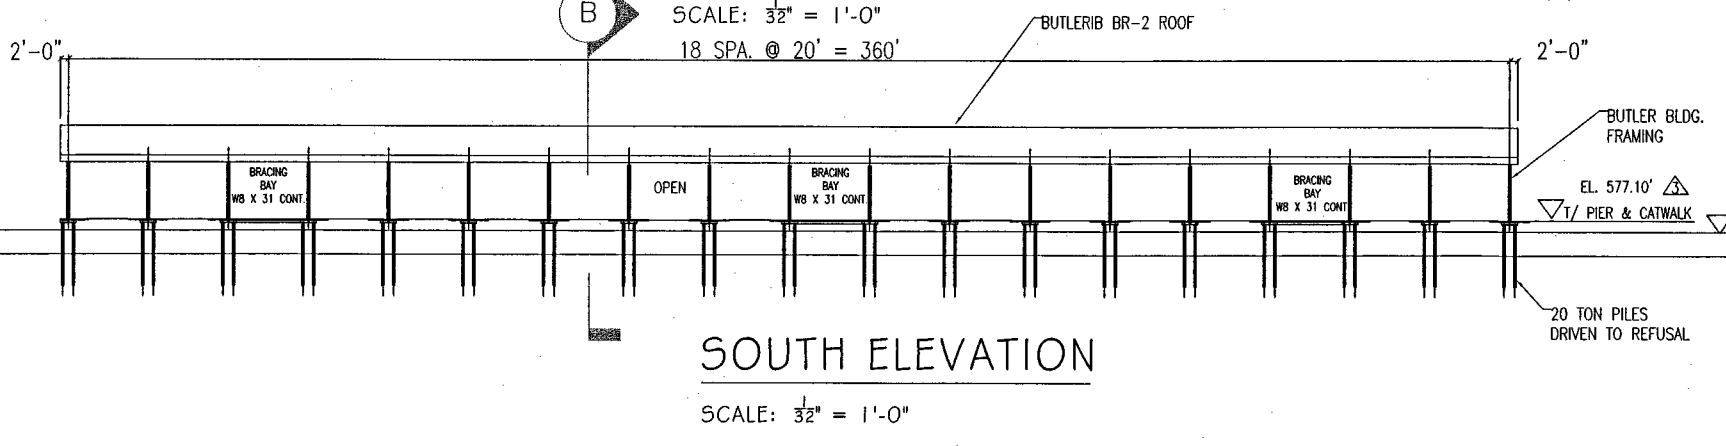

SOUTH ELEVATION
SCALE: 1/32" = 1'-0"

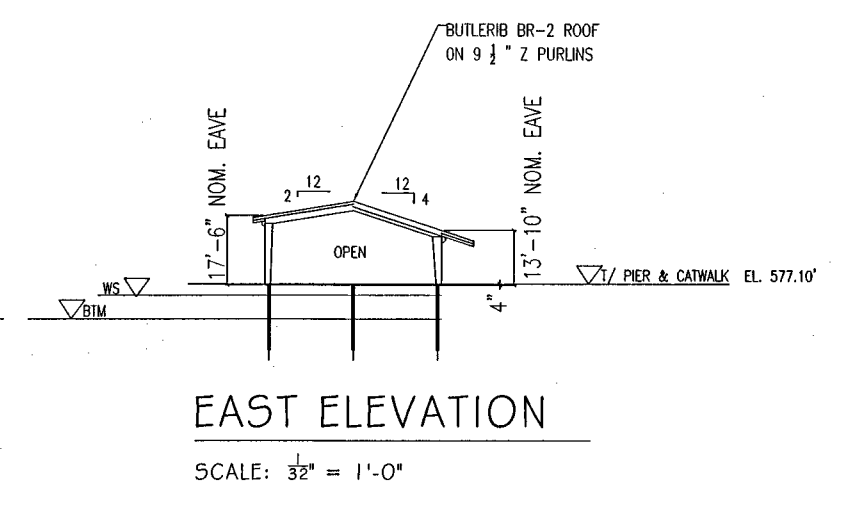


EAST ELEVATION
SCALE: 1/32" = 1'-0"

REV. No.	DATE	CH'K'D BY

DATE: 08-08-06
SCALE: HOR. 1"=100'
VERT. -
FOLDER: 2003 PROJECTS 03-502
FILENAME: DWG/PLATS/CONDO PHASE 1
TAB: PLAT 1-01
DRAWN: xxxxx


BAR HARBOR RESERVE
CONDOMINIUMS
DANBURY TOWNSHIP - OTTAWA COUNTY - OHIO

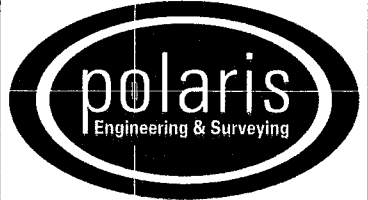


POLARIS ENGINEERING & SURVEYING, INC.
34600 CHARDON ROAD - SUITE D
WILLOUGHBY HILLS, OHIO 44094
(440) 944-4433 (440) 944-3722 (Fax)
www.polaris-es.com

CONDOMINIUM PHASE 1
BUILDING ELEVATIONS

CONTRACT No.	
03-502	
SHEET	OF
3	4

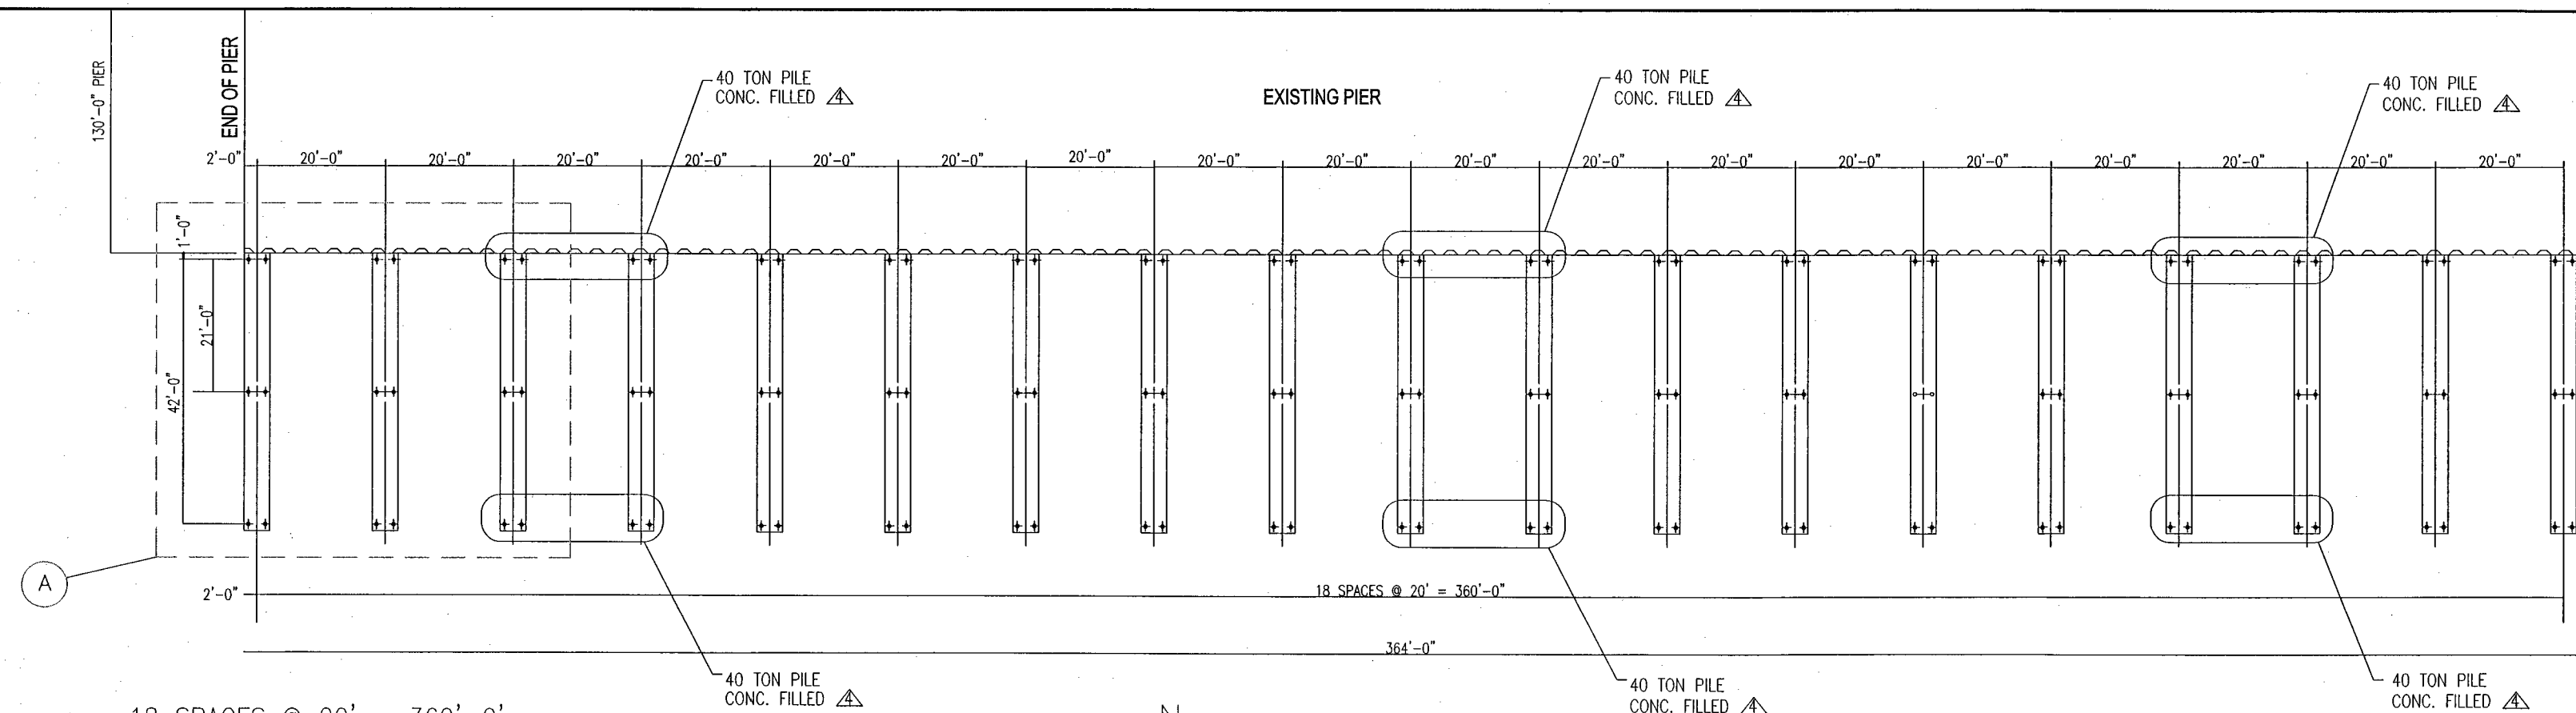


PILING LOCATION PLAN
SCALE: 1/16" = 1'-0"

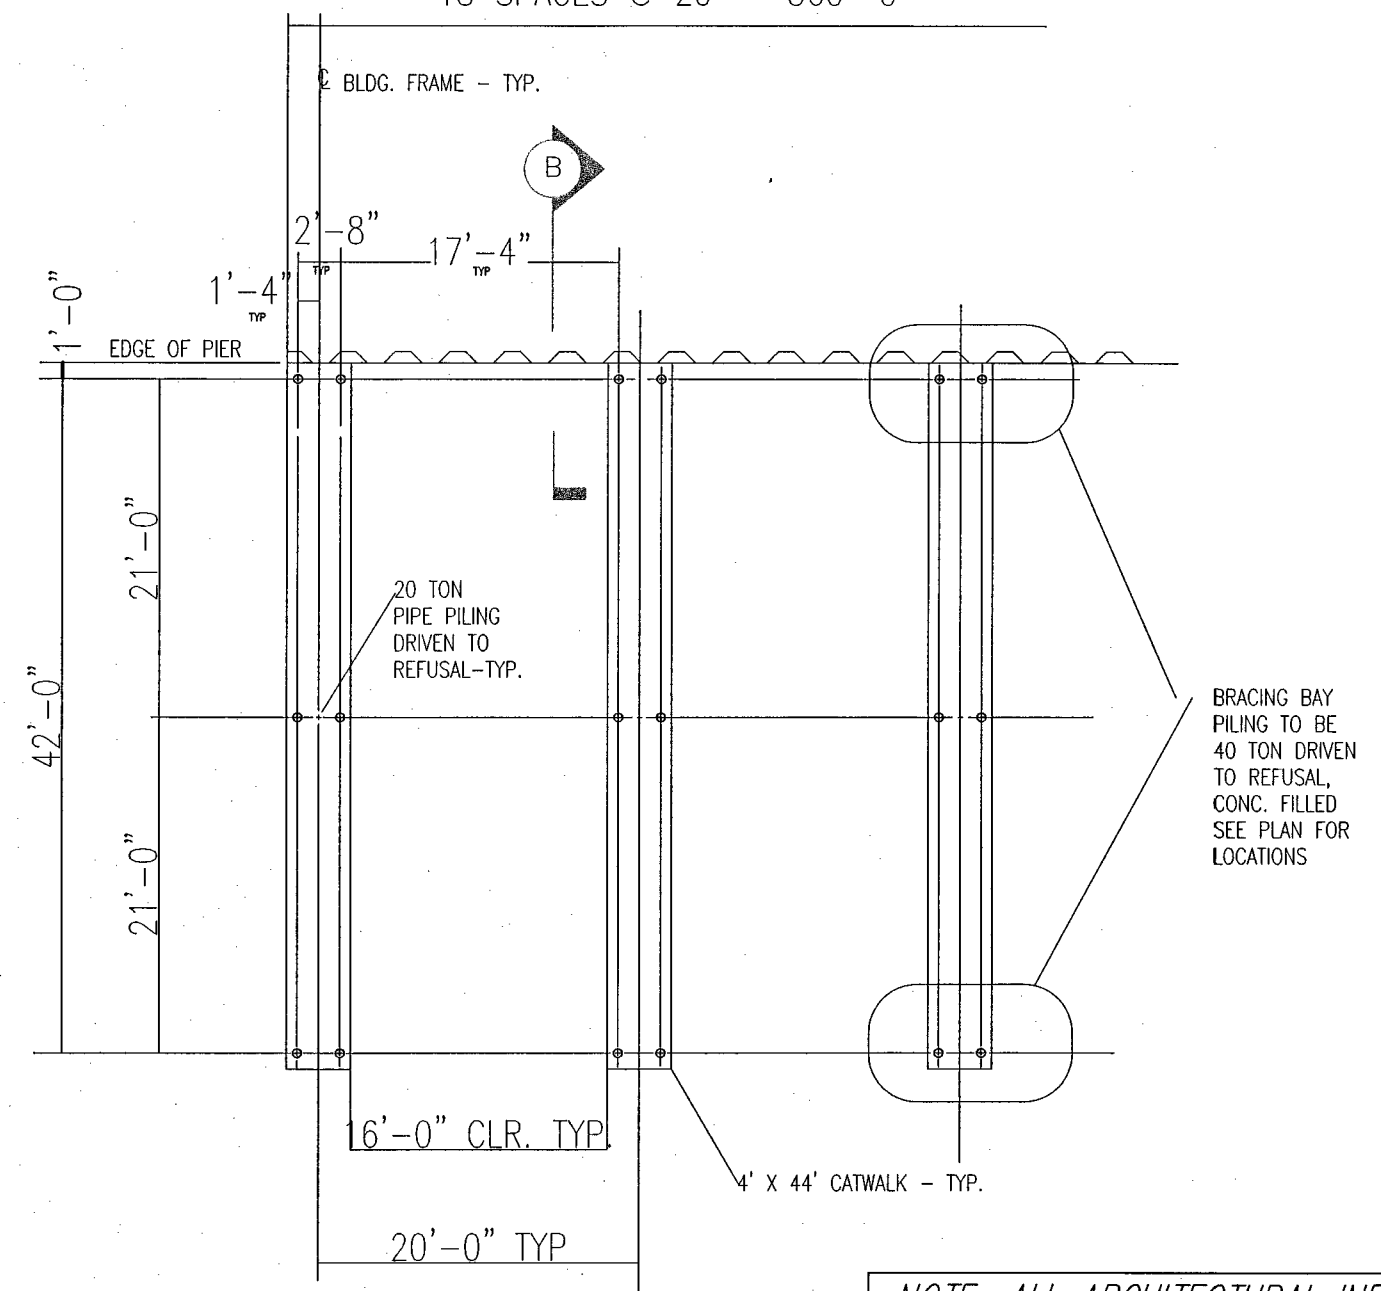

A ENLARGED PLAN
SCALE: 1/8" = 1'-0"

NOTE: ALL ARCHITECTURAL INFORMATION SHOWN ON PAGES 3 AND 4 OF THIS EXHIBIT WAS TAKEN FROM PAGES A-1 AND A-2 OF PLANS PREPARED BY A.V. LAKE CONSTRUCTION COMPANY IN SEPTEMBER, 2005 AND PROVIDED TO POLARIS ENGINEERING AND SURVEYING ON MAY 17, 2006.

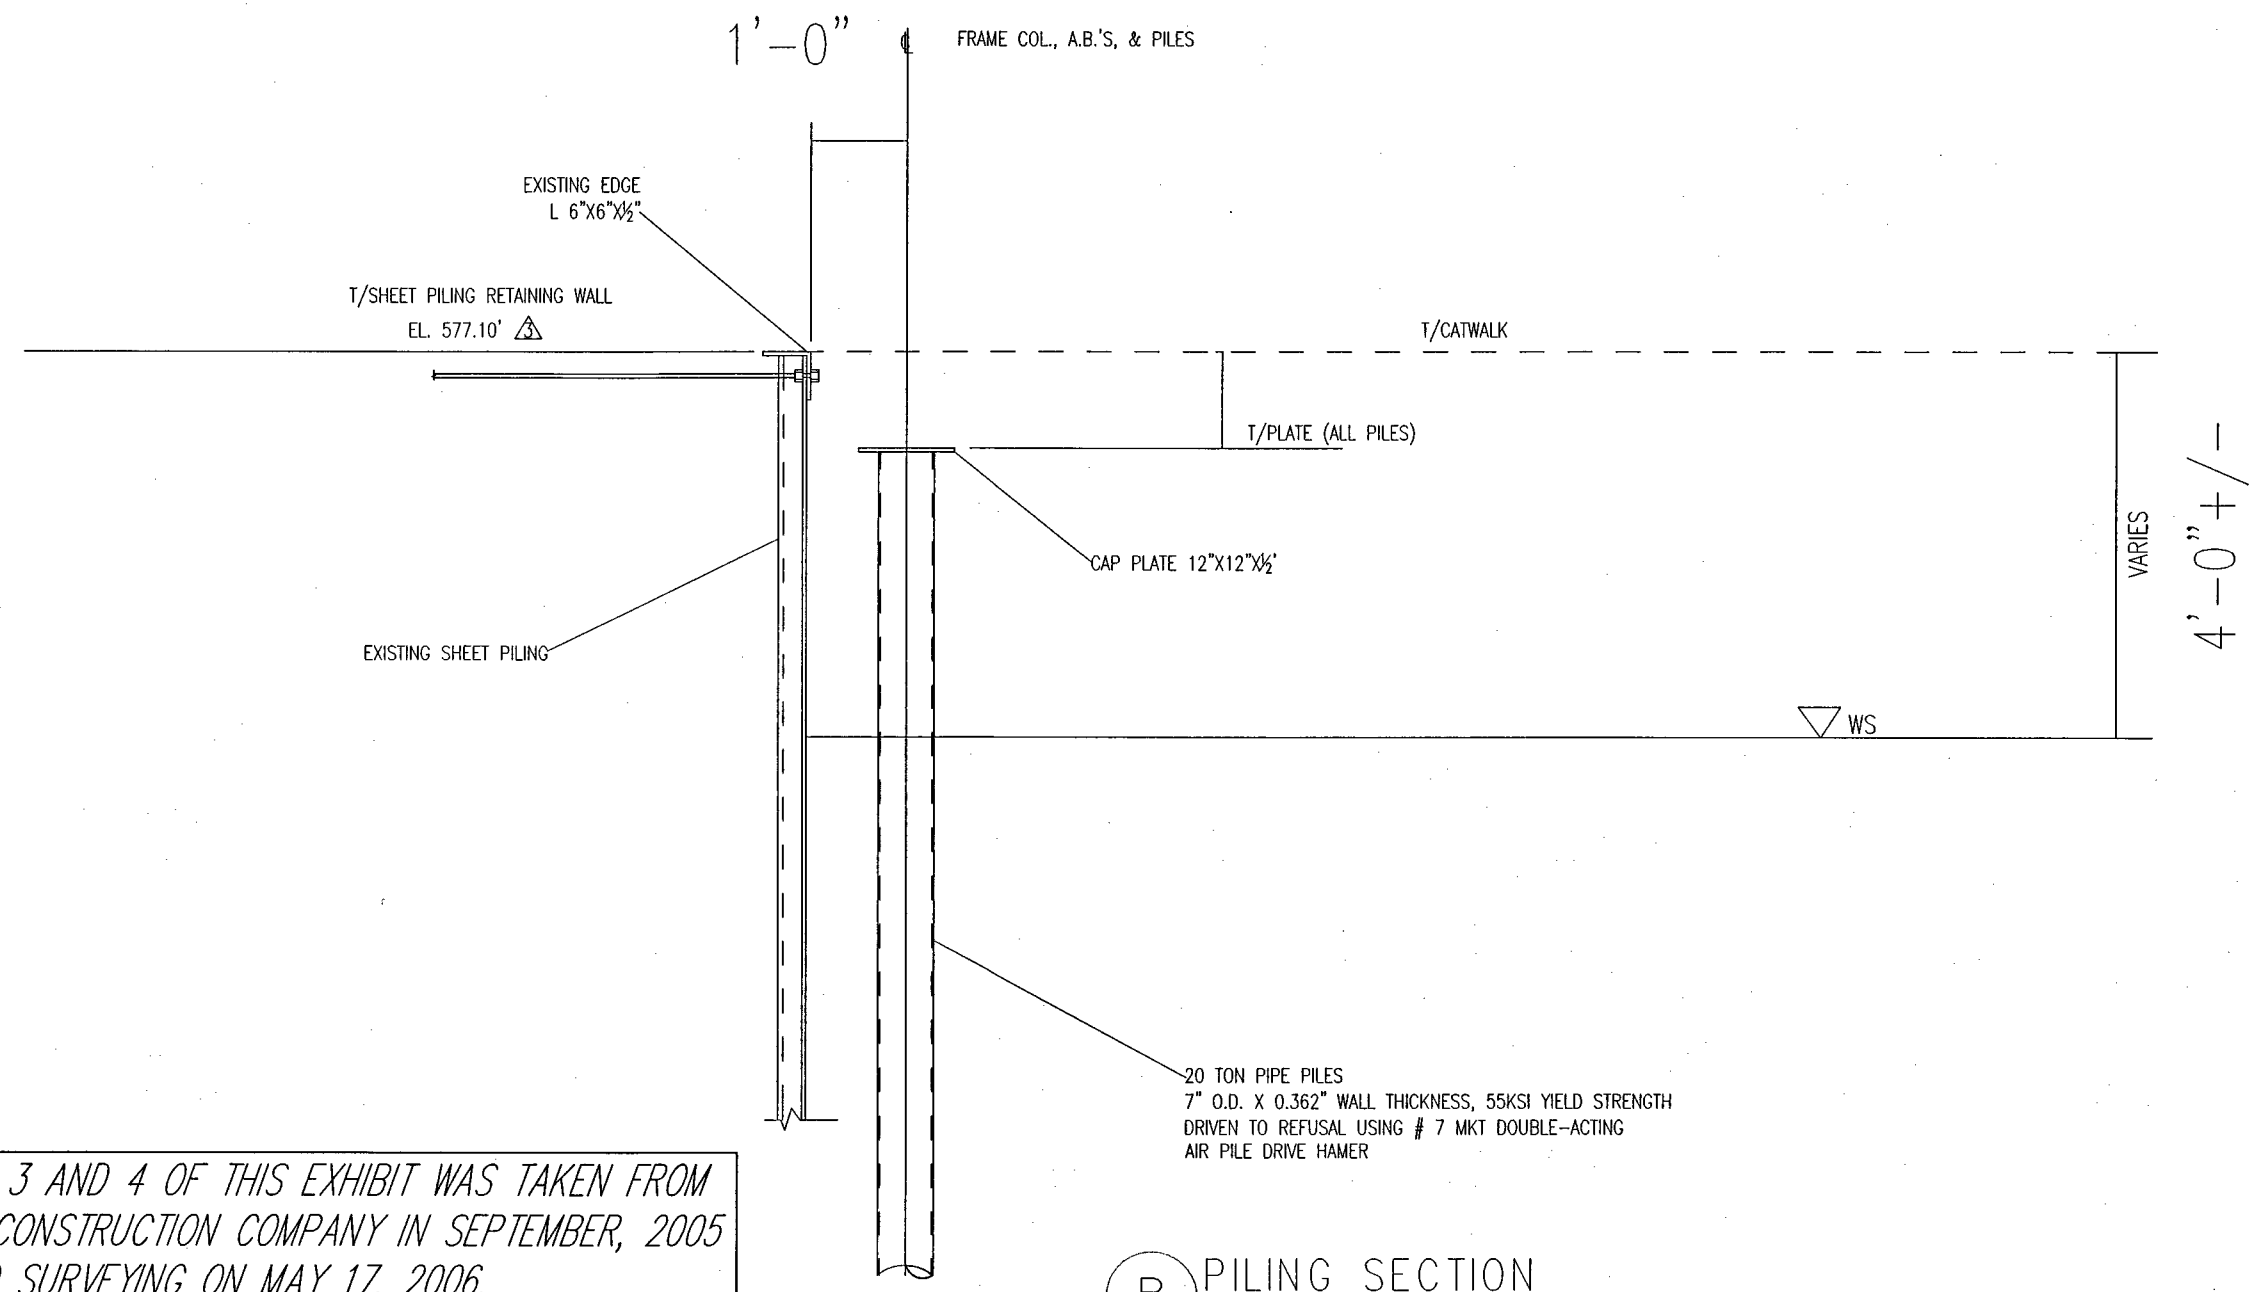


B PILING SECTION
SCALE: 3/4" = 1'-0"

REV. No.	DATE	CH'K'D BY

DATE: 08-08-06
SCALE: HOR. 1"=100'
VERT. -
FOLDER: 2003 PROJECTS 03-502
FILENAME: DWG/PLATS/CONDO PHASE 1
TAB: PLAT 1-01
DRAWN: xxx

BAR HARBOR RESERVE
CONDOMINIUMS
DANBURY TOWNSHIP - OTTAWA COUNTY - OHIO

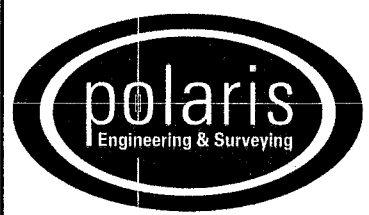

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CONDOMINIUM PHASE 1
CONSTRUCTION DETAILS

CONTRACT No.	
03-502	
SHEET	OF
4	4