




Ohio Living Vineyard on Catawba

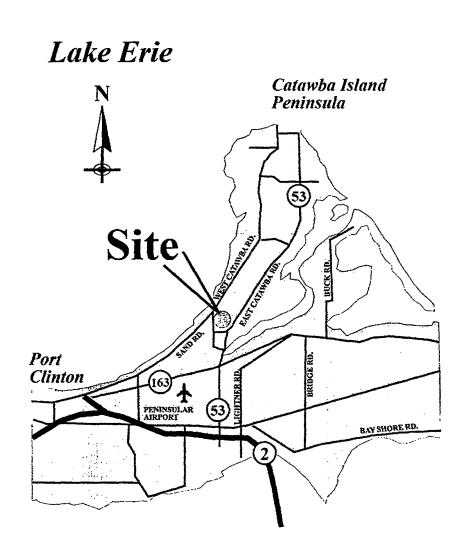


DRAWING SCHEDULE


- FLOOR PLAN FIRST FLOOR FRAMING **ROOF FRAMING PLAN BUILDING SECTIONS DETAILS & SECTIONS**
- PLUMBING LAYOUT
- MECHANICAL LAYOUT
 - **ELECTRICAL LAYOUT**

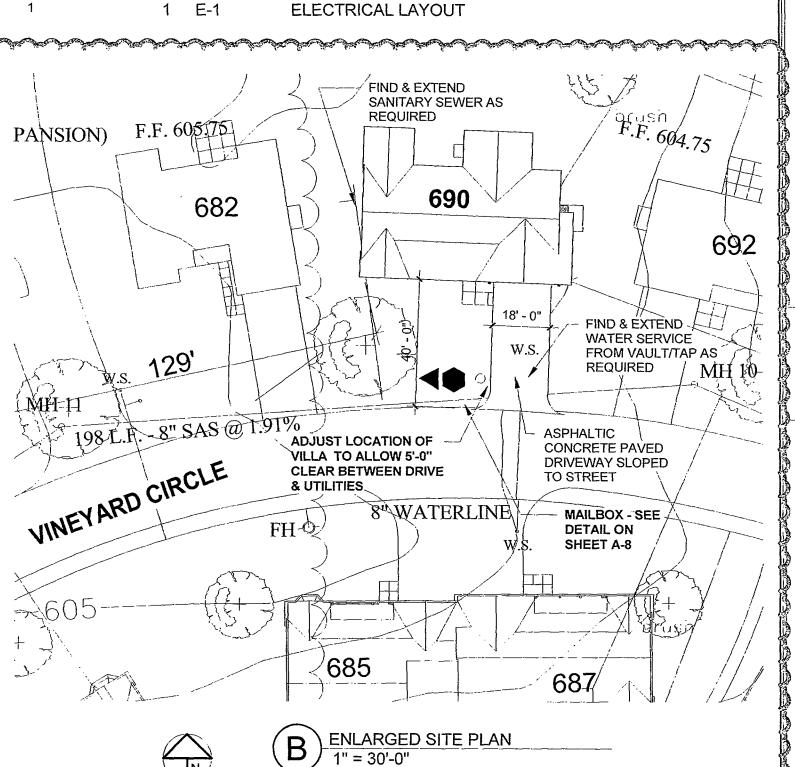

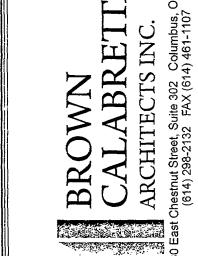

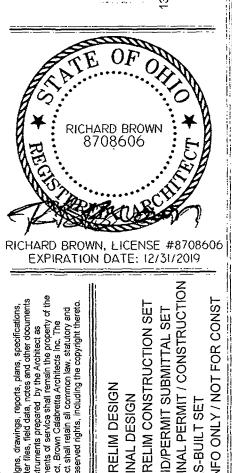

OHI VINEYARE

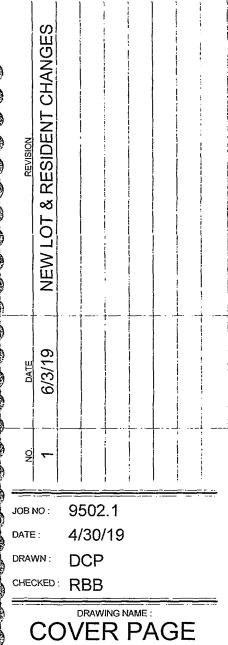

3 of 13

SHEET NO.

A-1

FF 615.75'

VINEYARD VILLAGE DRIVE

EX. MH 2 C

PAVILION

COMMUNITY GARDENS

FUTURE MAINT.

3 PHASE ELECTRIC


EXPANSION

TOP OF BEOCK 608 7 12


COMMUNITY

10 UNIT MINI-RCF


FUTURE SINGLE FAMILY

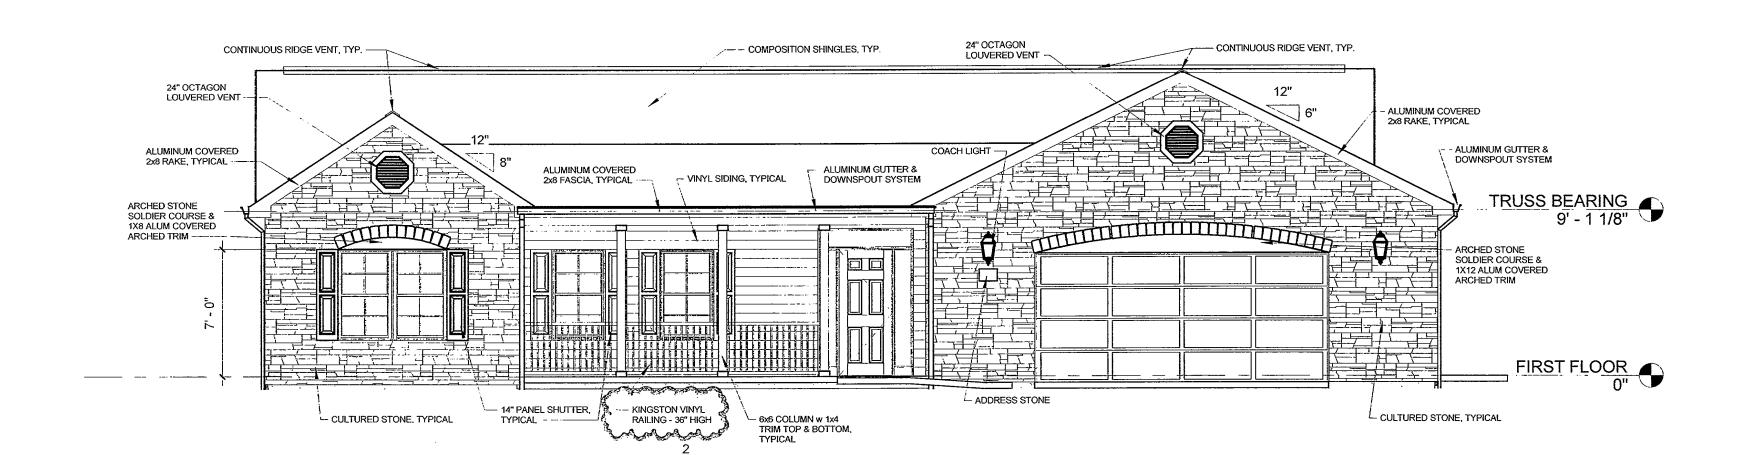


A FRONT ELEVATION
3/16" = 1'-0"

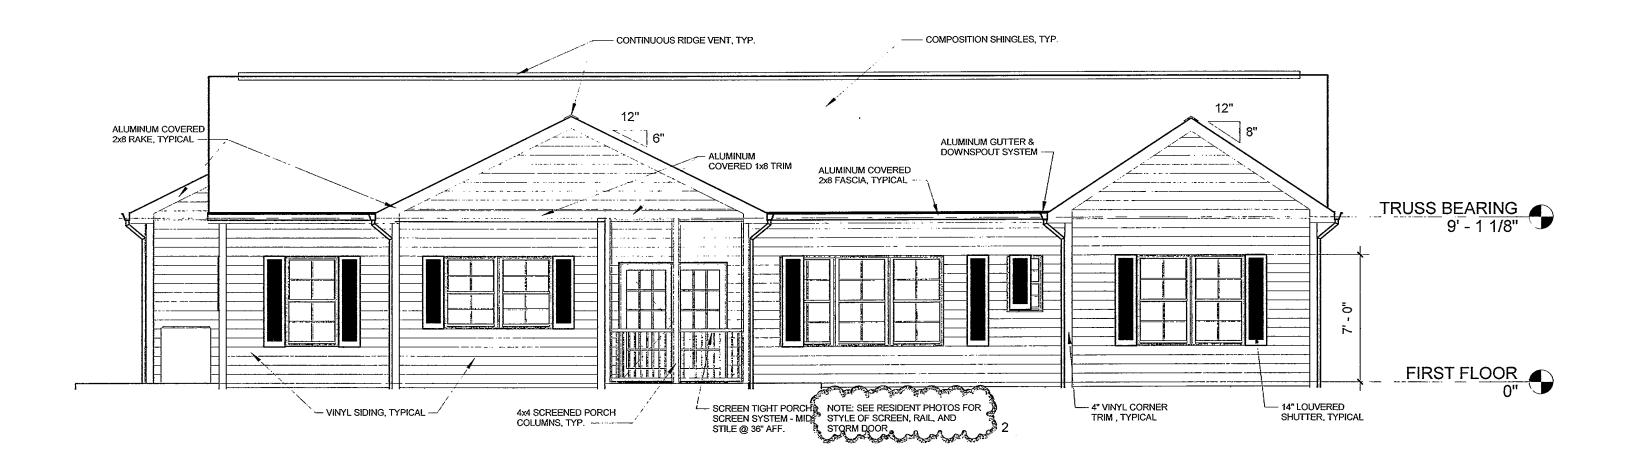


REAR ELEVATION
3/16" = 1'-0"

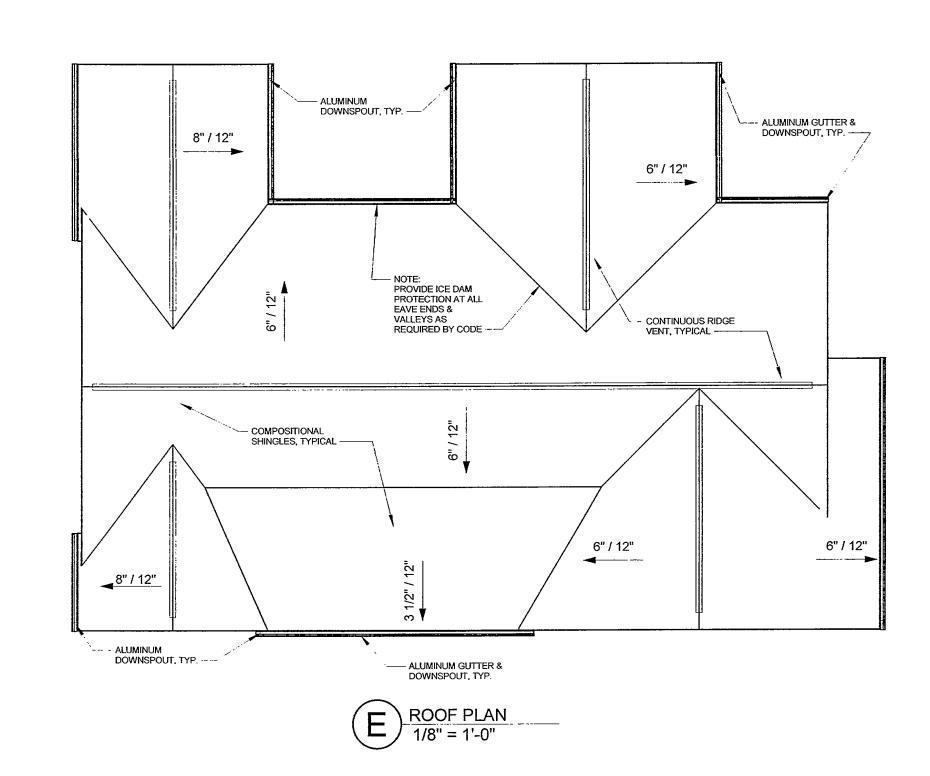


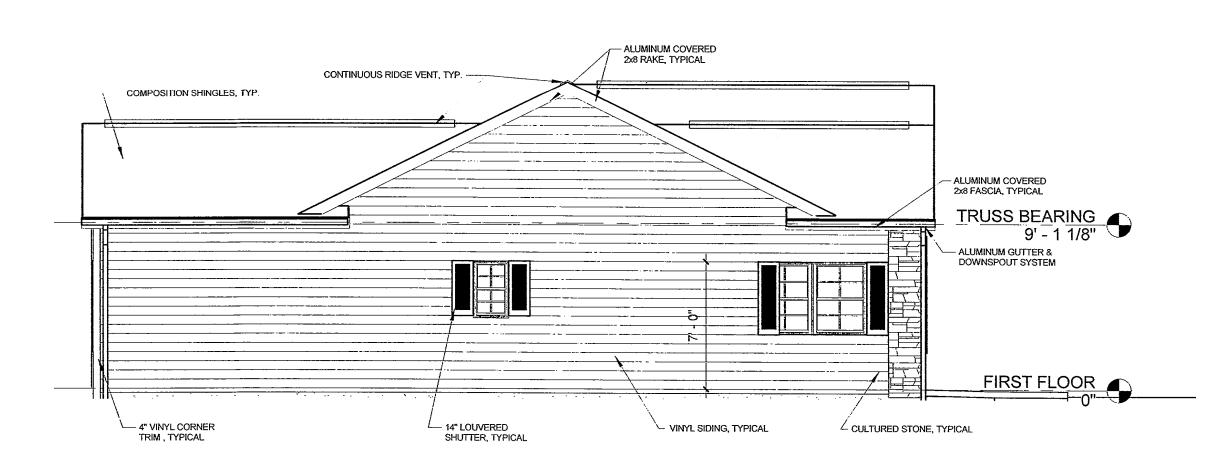



B LEFT ELEVATION
3/16" = 1'-0"

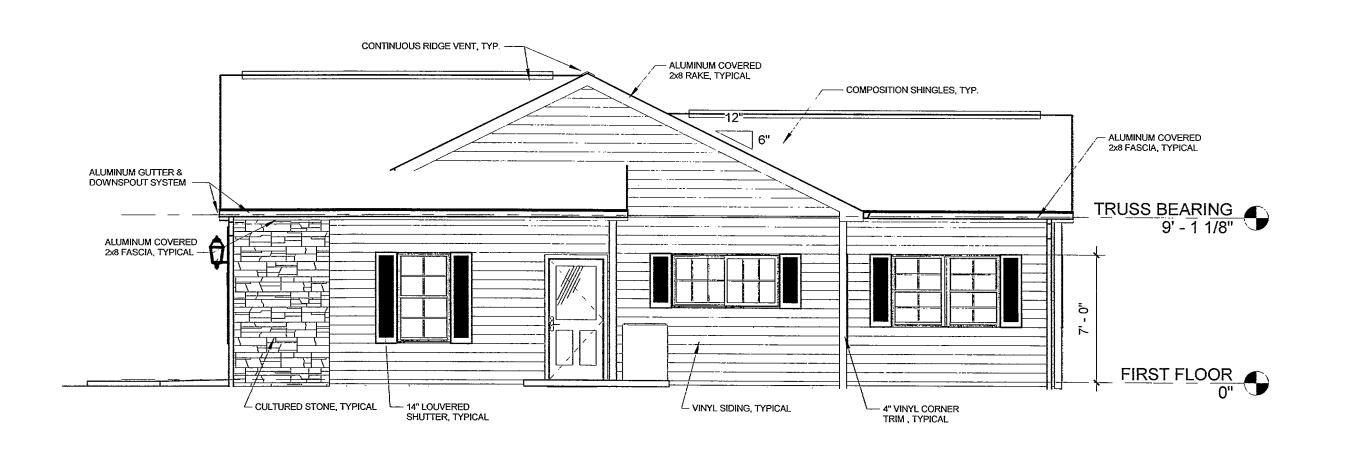

RIGHT ELEVATION
3/16" = 1'-0"

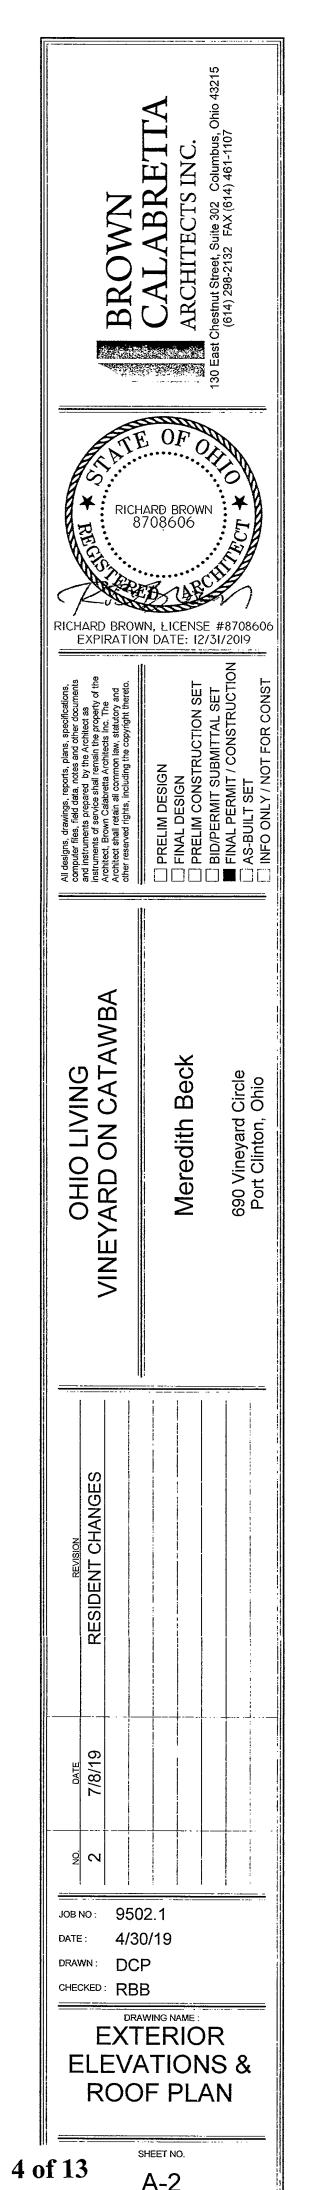

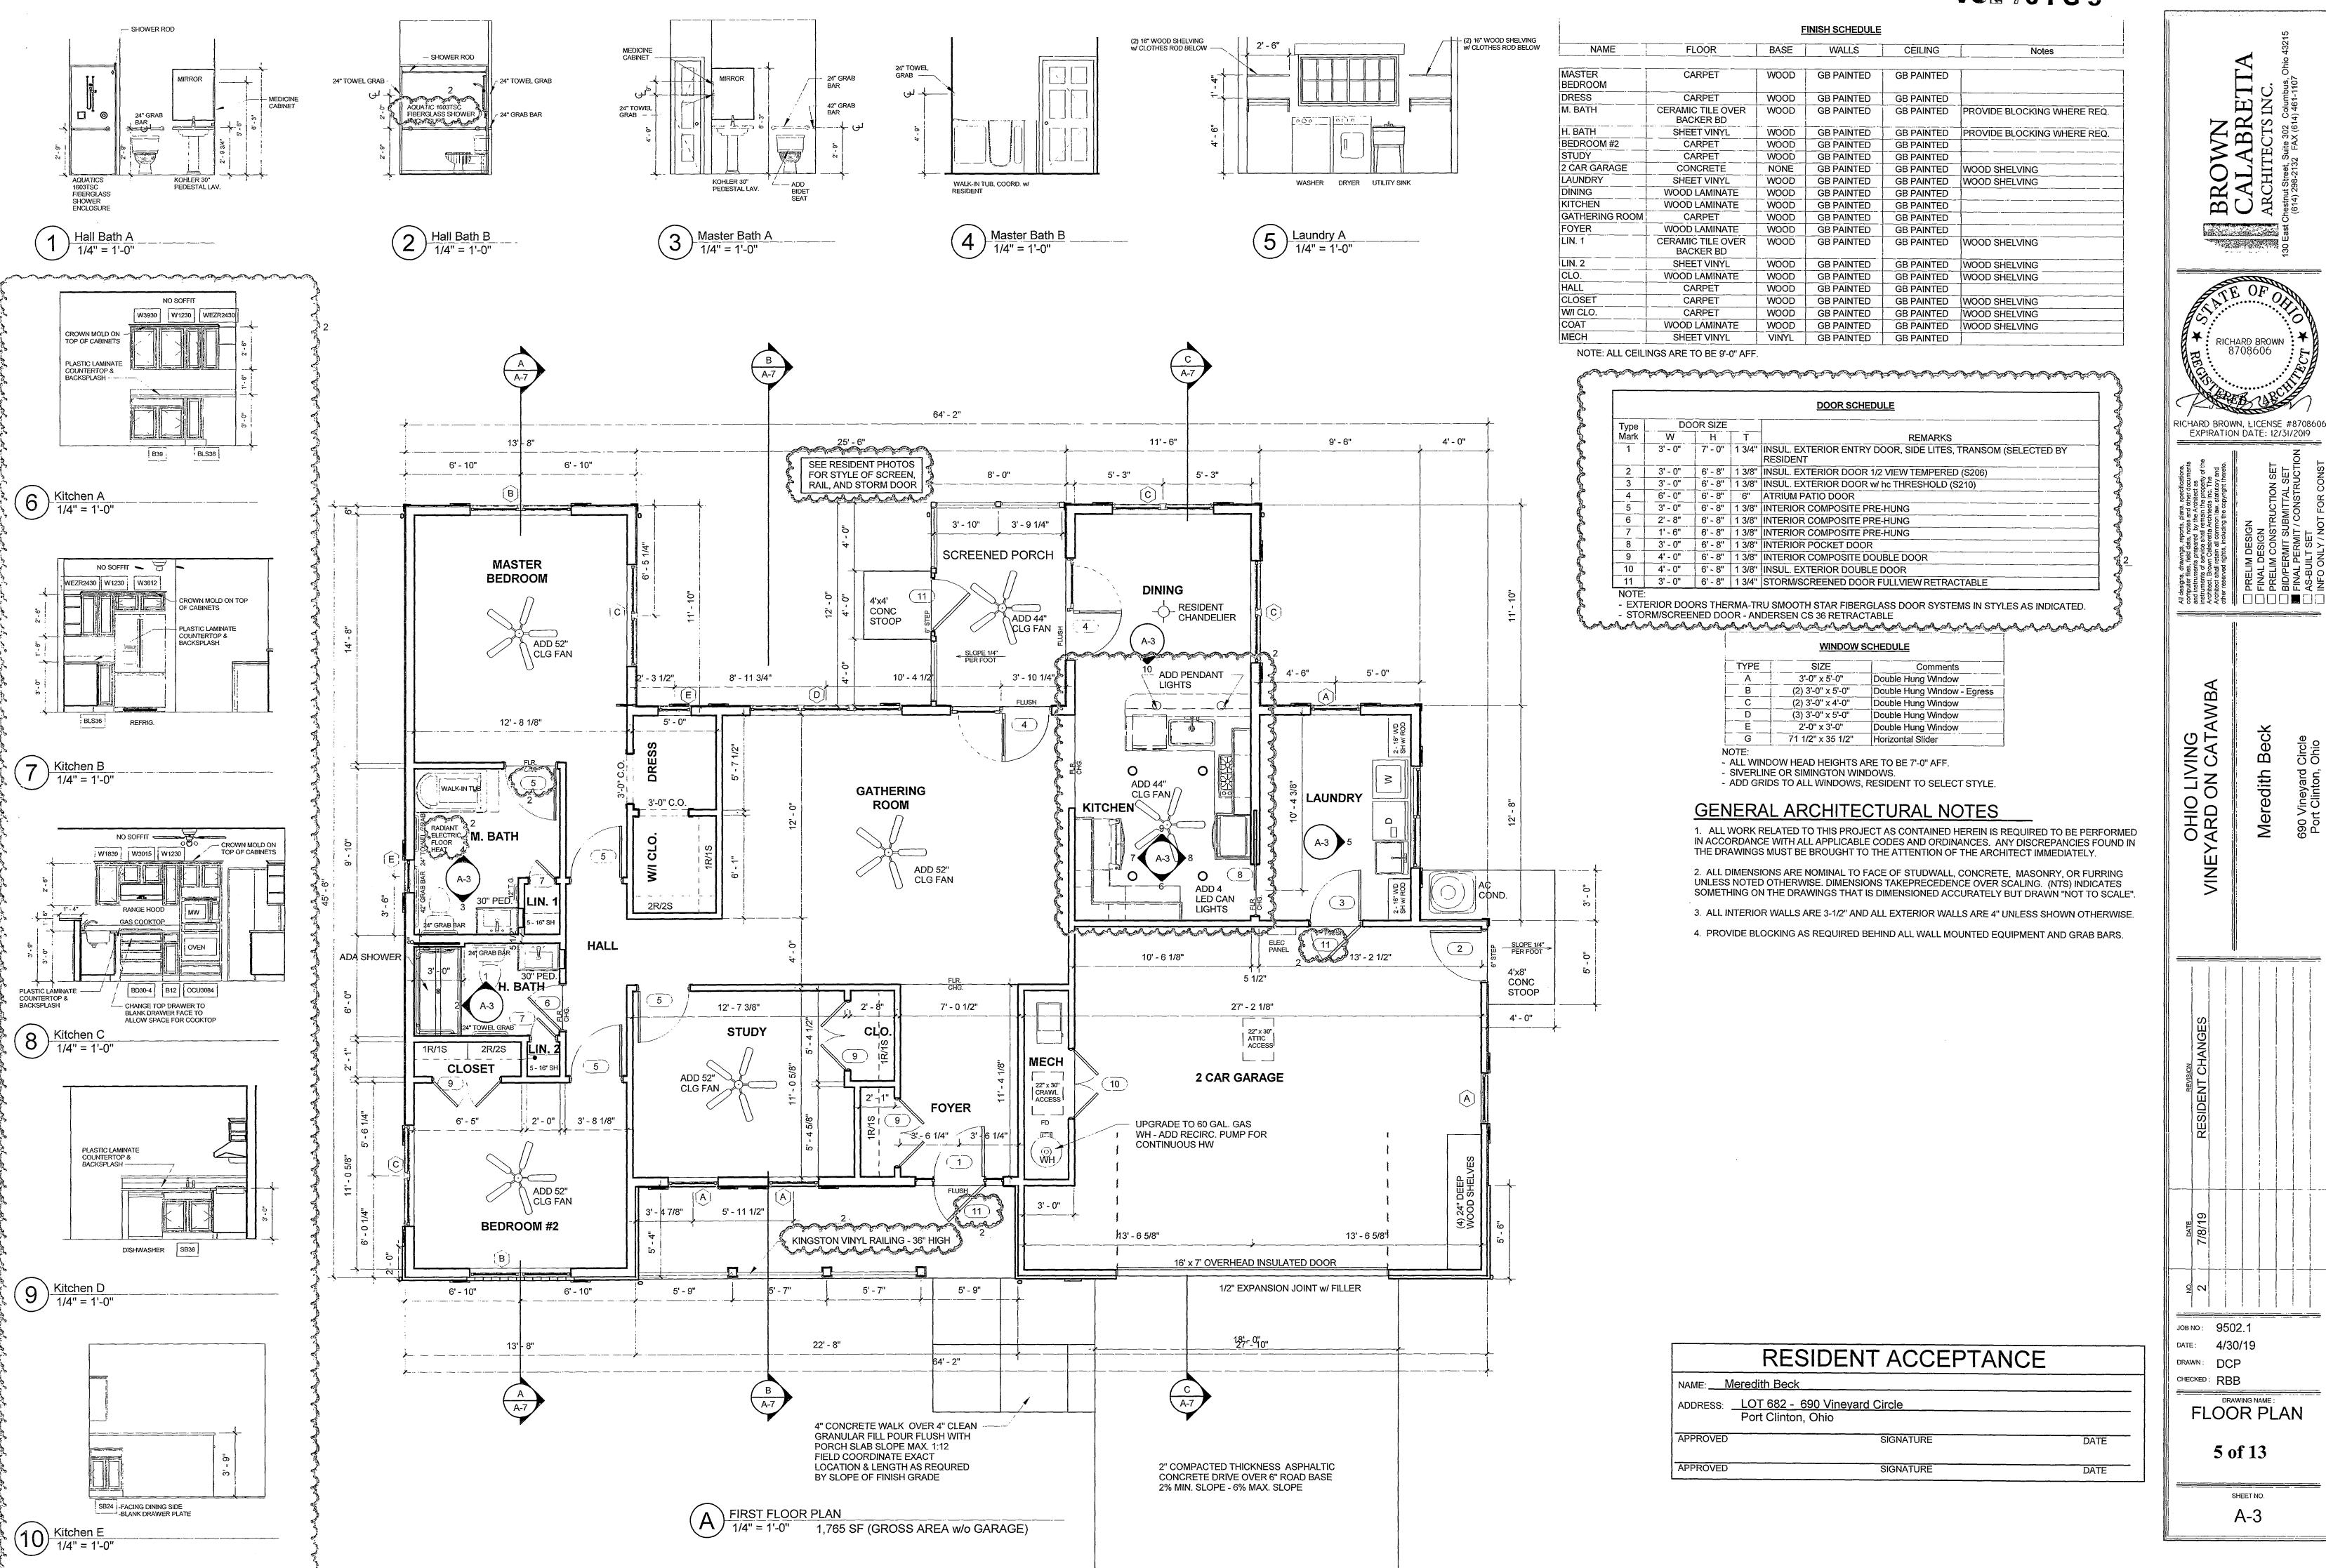

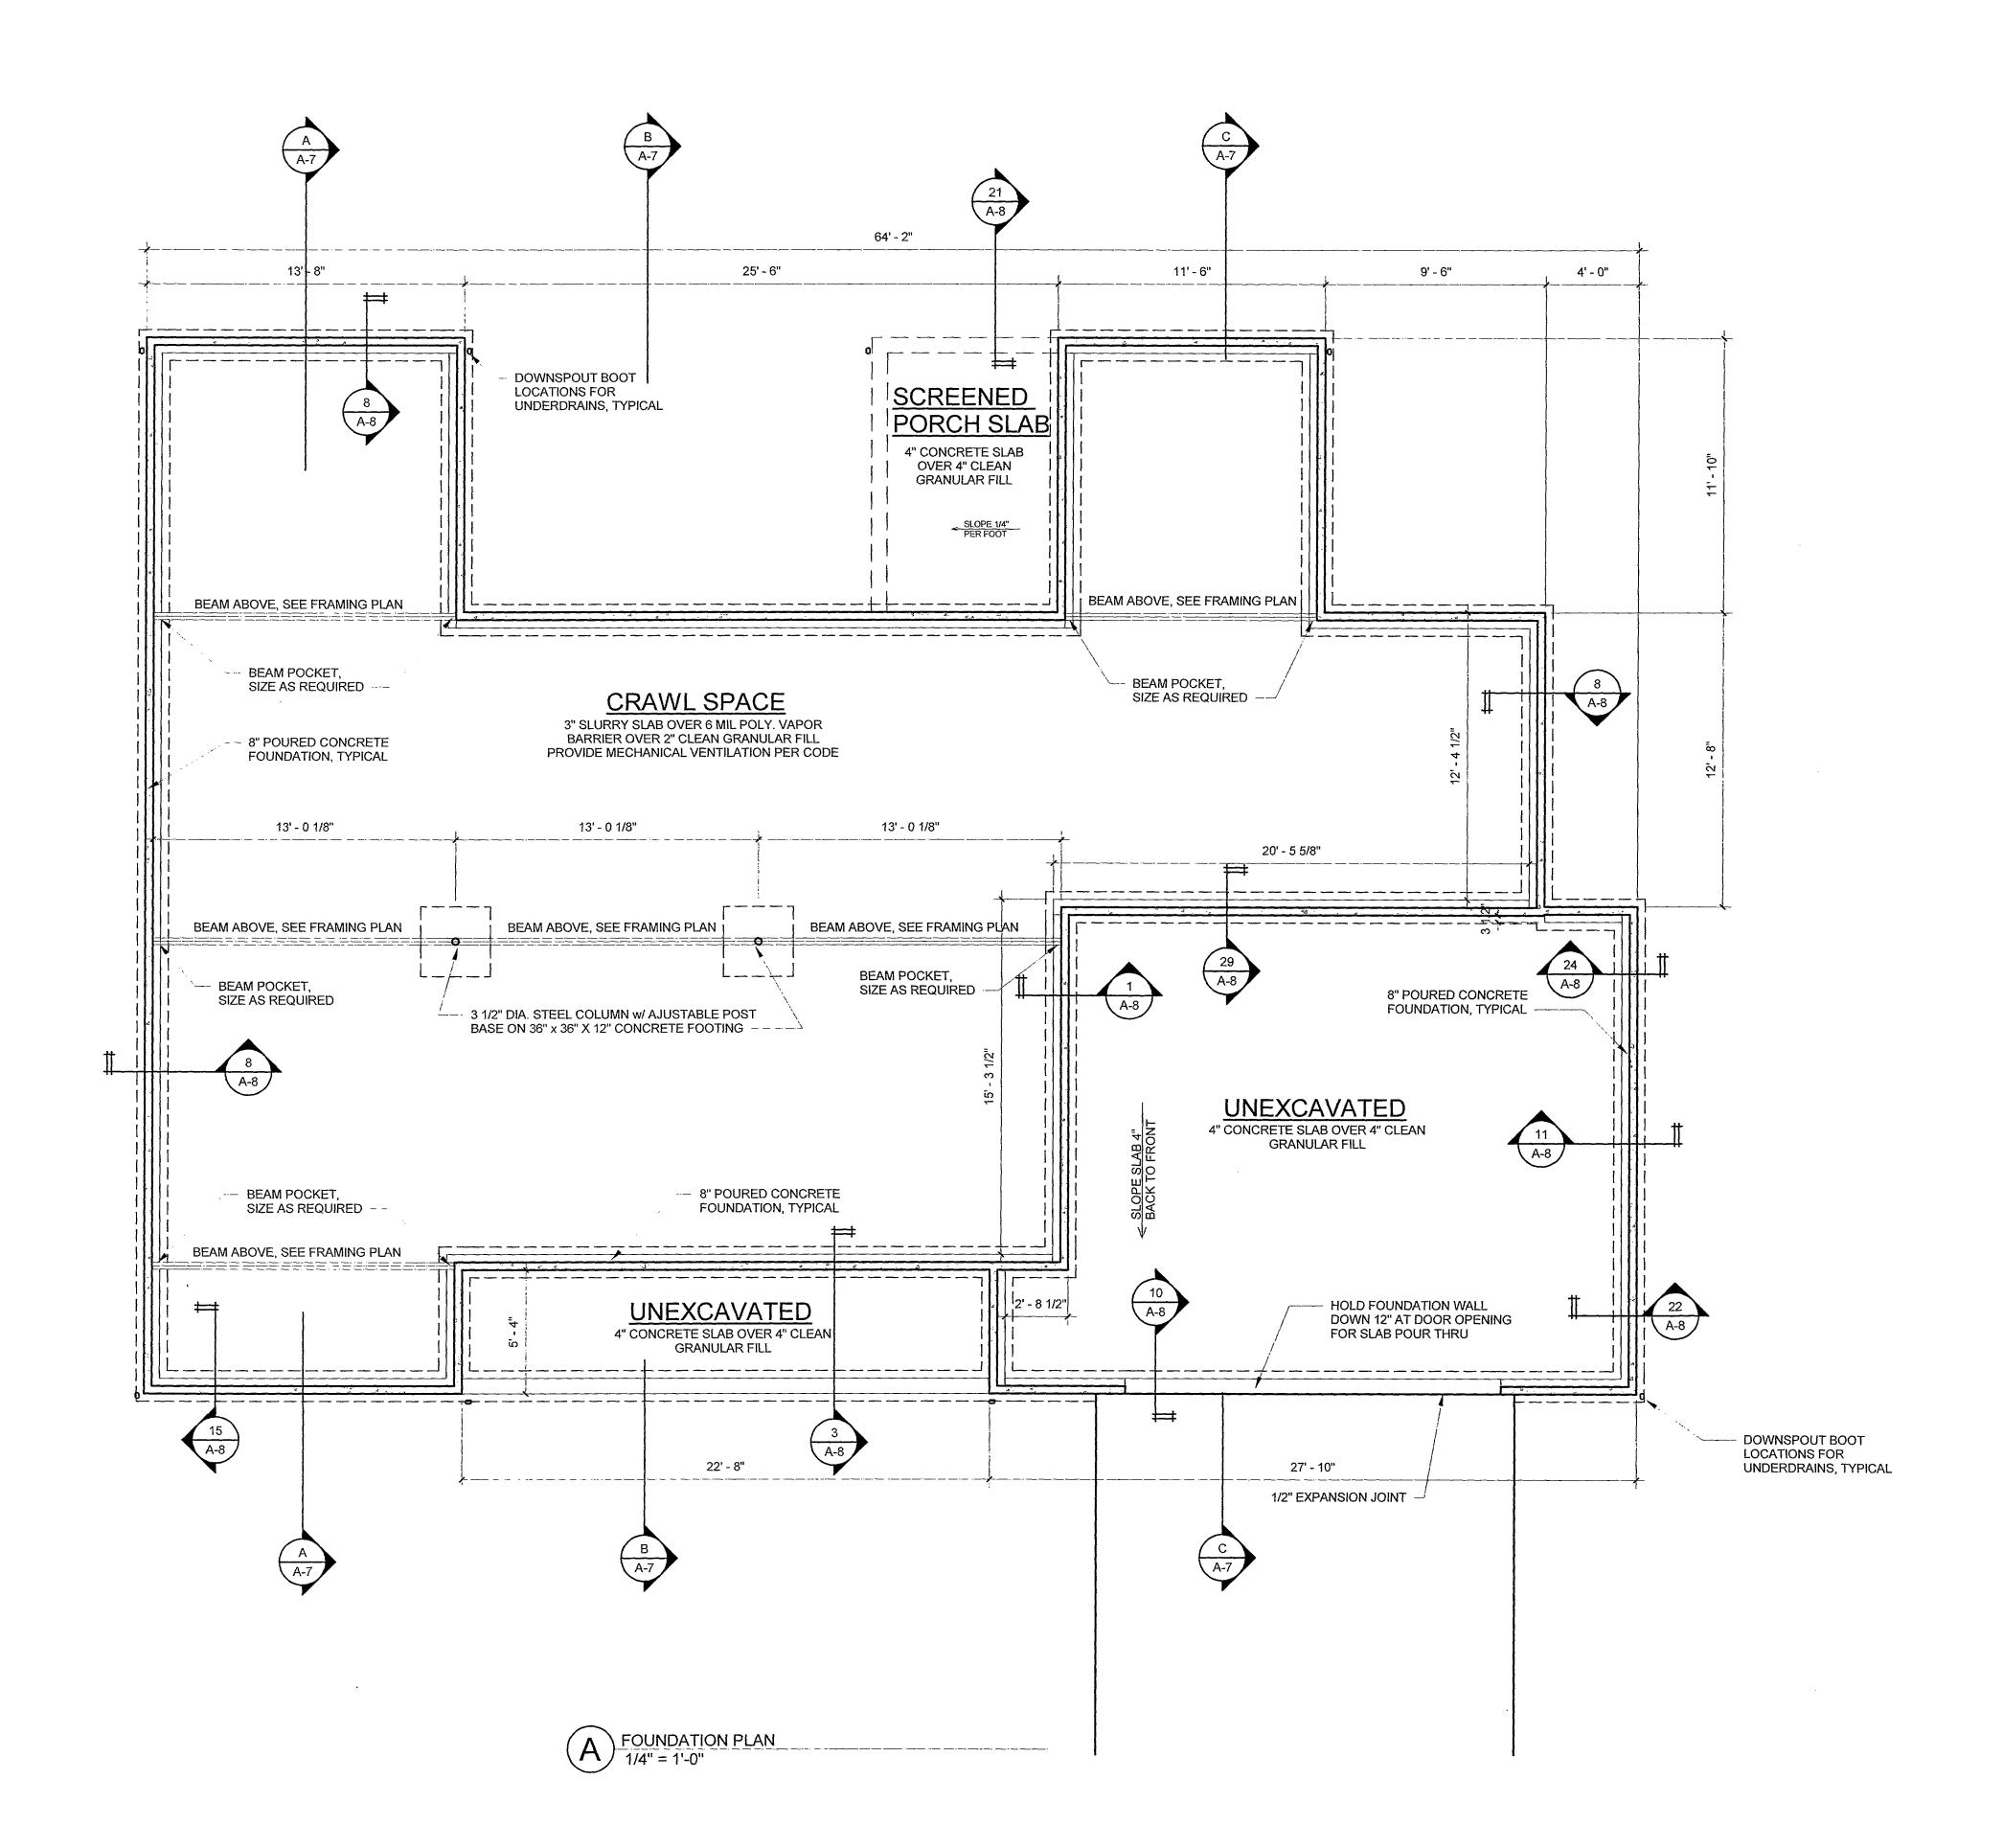

GENERAL FOUNDATION NOTES

COVER SHALL BE PROVIDED OVER ALL STEEL.

1. ALL FOUNDATION WALLS SHALL BE 36" MINIMUM BELOW GRADE TO BOTTOM OF FOOTING OR AS REQUIRED BY LOCAL AUTHORITY.

2. ALL CONCRETE SHALL BE TYPE I PORTLAND CEMENT, = Fc = 3000 PSI MINIMUM AFTER 28 DAYS. SLABS ON GRADE SUBJECT TO DE-ICING SHALL BE TYPE II CEMENT.

3. ALL FOOTINGS SHALL BE FOUNDED ON NATURAL UNDISTURBED OR PROPERLY COMPACTED SOIL. (95% STANDARD PROCTOR DENSITY)

4. REINFORCING STEEL SHALL BE Fy = 40 KSI (40 GRADE). A MINIMUM OF 3" OF CONCRETE

5. ASSUMED SOIL BEARING CAPACITY = 2,000 PSF (CONTRACTOR VERIFY). IF A PROFESSIONALLY ENGINEERED SOILS REPORT HAS BEEN PROVIDED BY THE OWNER, THOSE FOUNDATION RECOMMENDATIONS SHALL TAKE PRECEDENCE OVER THAT STATED AND ASSUMED ABOVE.

6. DESIGN LIVE LOADS: ROOF ≈ 25 PSF FLOOR = 40 PSF

7. STRAP ANCHORS OR 1/2" DIAMETER ANCHOR BOLTS SHALL BE EMBEDDED 16" MINIMUM INTO FOUNDATION PLACED 4'-0" O.C. MAXIMUM AND 1'-0" FROM EACH CORNER THROUGH-OUT

8. ALL BACKFILLED PERIMETER BASEMENT FOUNDATION WALLS SHALL RECEIVE WATERPROOFING FULL HEIGHT TO GRADE AS PER CODE.

9. INCLUDE A CONCRETE ENCASED ELECTRODE PER NEC 2014 SECTION 250.52. COORDINATE WITH ELECTRICAL WORK.






RICHARD BROWN, LICENSE #8708606 EXPIRATION DATE: 12/31/2019

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DRAWN: DCP CHECKED: RBB

FOUNDATION PLAN 6 of 13



GENERAL FRAMING NOTES:

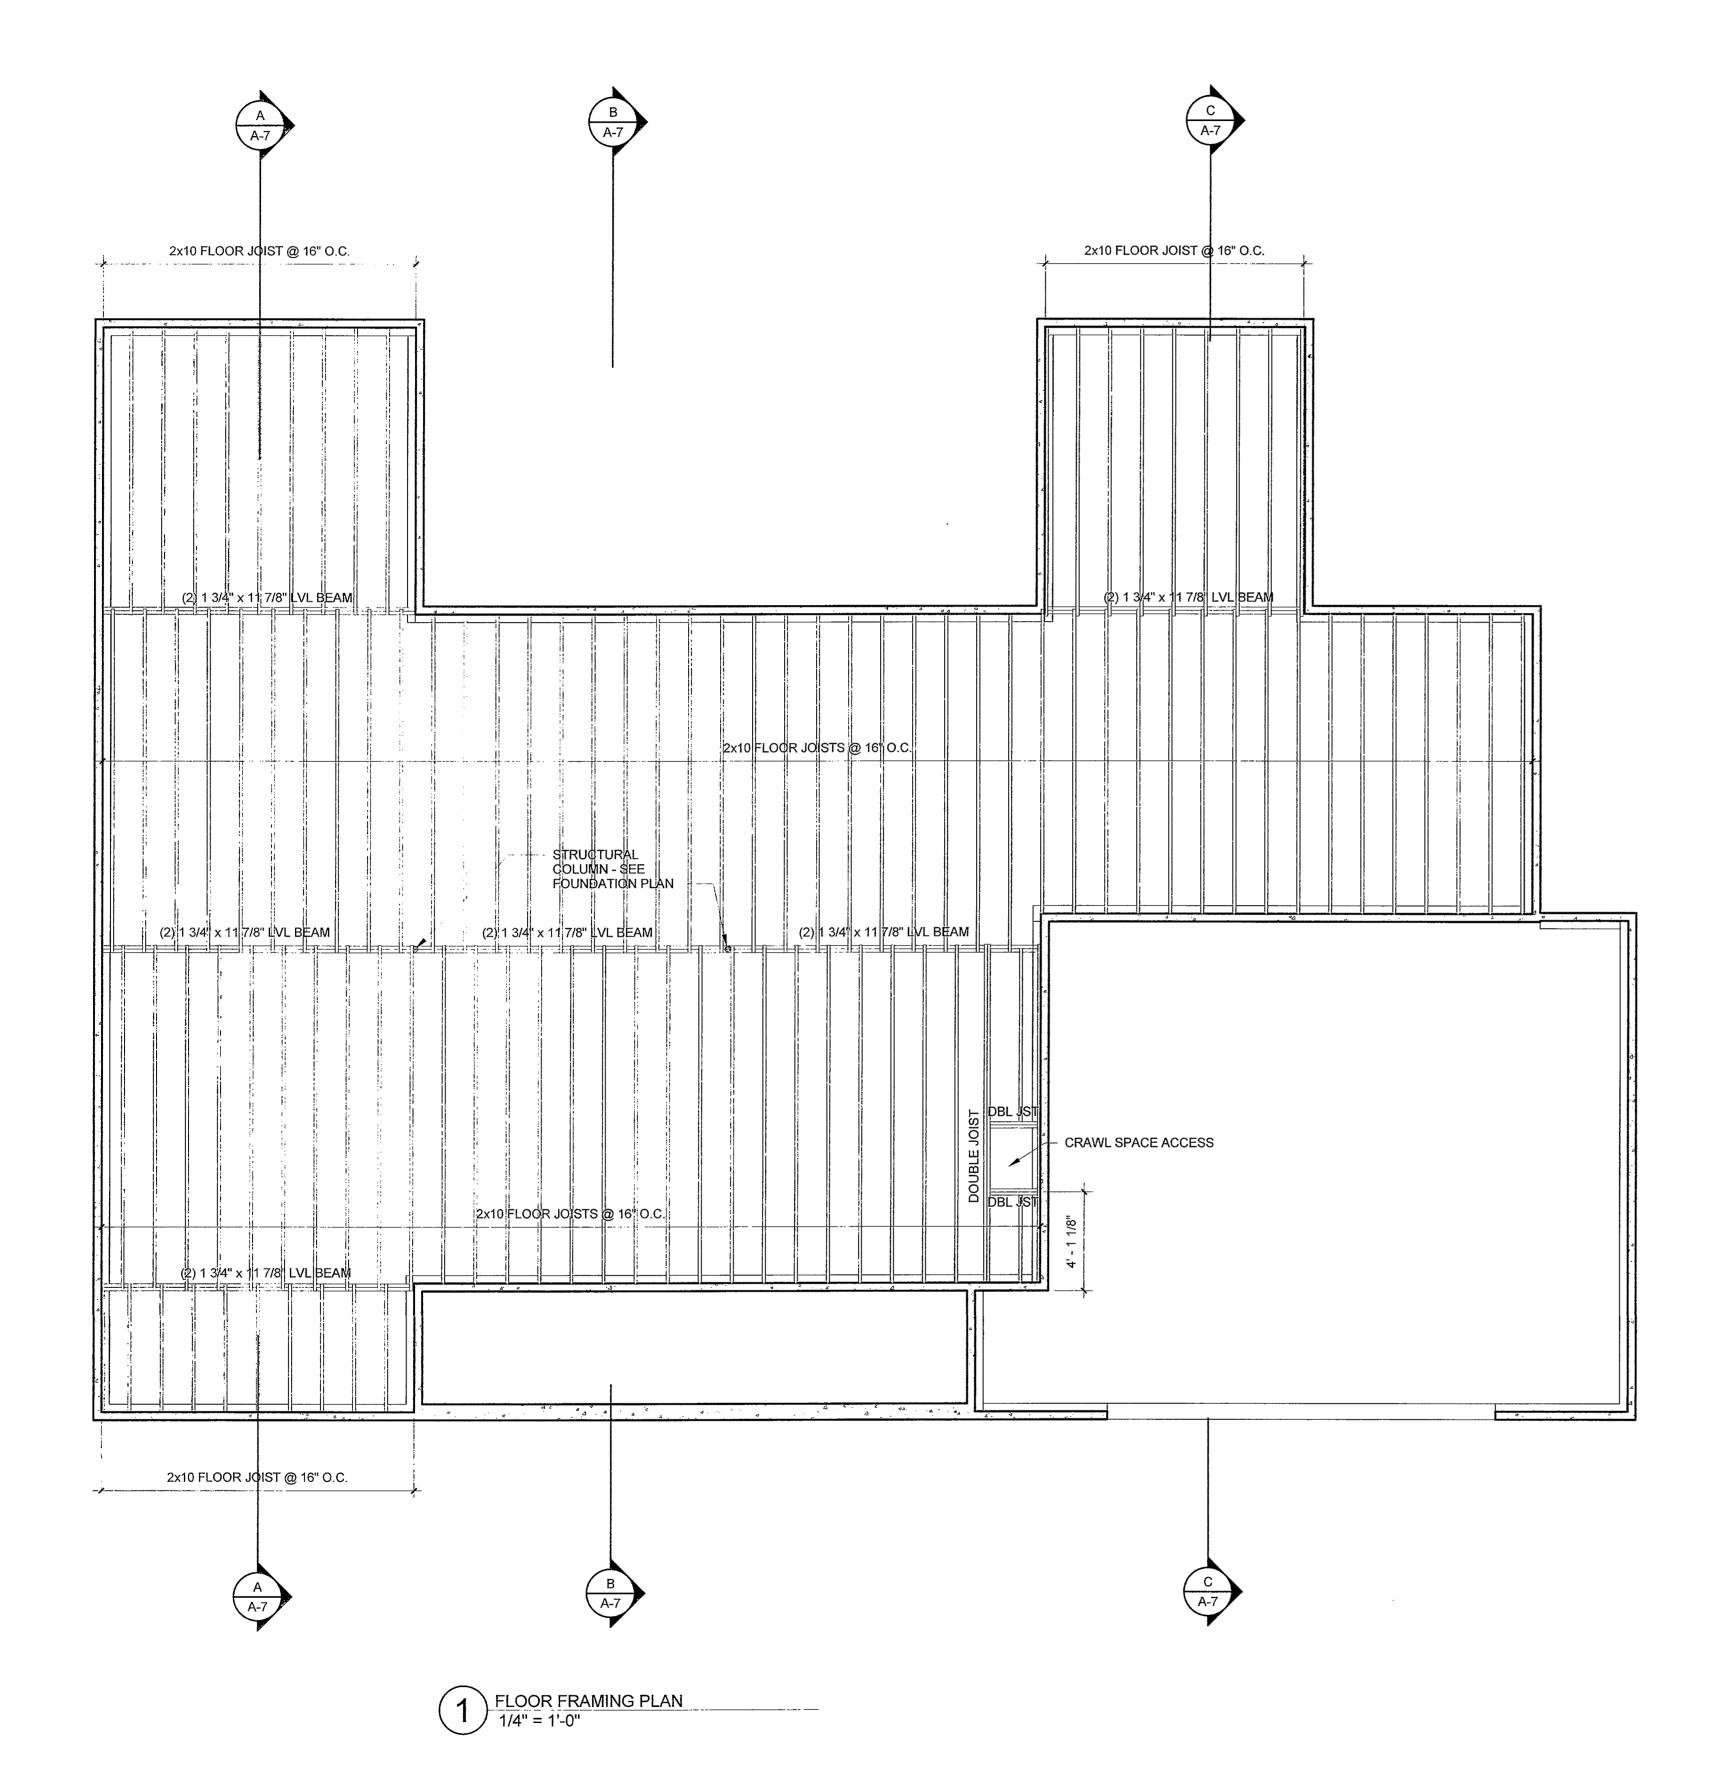1. ALL STRUCTURAL FRAMING LUMBER SHALL BE SPRUCE PINE FIR (SPF) NO. 2, FB=1000 PSI OR BETTER, OR AS PRE-ENGINEERED. ALL EXPOSED DECKING LUMBER SHALL BE "PRESSURE TREATED"

2. DESIGN LOADS USED:

ROOF (LIVE & DEAD) 40 PSF FLOOR (LIVE & DEAD) 55 PSF DECK (LIVE & DEAD) 75 PSF

CEILING (LIVE ONLY) 20 PSF (ATTIC SPACES WITHOUT STAIRS)

WIND (LIVE ONLY) 90 MPH


- 3. ALL MUDSILL PLATES SHALL BE PRESSURE TREATED AND SET ON CONTINUOUS SILL SEALER.
- 4. ALL EXTERIOR WALL CONSTRUCTION SHALL BE 2X6 STUDS AT 16" O.C., WITH R-21 MINIMUM INSULATION AND 4 MIL POLYETHYLENE VAPOR BARRIER TO THE INSIDE FACE OF STUDS, WITH 1/2" OSB SHEATHING AND 'TYVEK HOUSEWRAP' TO OUTSIDE FACE OF STUDS.
- 5. ALL INTERIOR WALL CONSTRUCTION SHALL BE 2X4 STUDS AT 16" O.C. OR 2X6 STUDS AT 16" O.C. (IF DIMENSIONED 5 1/2"), WITH 1/2" GYPSUM BOARD OVER BOTH FACES UNLESS OTHERWISE NOTED.
- 6. ALL EXTERIOR OPENINGS (DOORS, WINDOWS, ETC.) SHALL HAVE MINIMUM (2) 2X6 HEADERS UNLESS OTHERWISE NOTED ON THE DRAWINGS. INSULATE ALL HEADER CAVITIES WITH 2" RIGID INSULATION ON INSIDE FACE
- 7. PROVIDE A MINIMUM OF (2) SOLID STUDS CONTINUOUS TO FOUNDATION UNDER EACH END OF ALL BEAMS AND HEADERS UNLESS NOTED OTHERWISE ON THE DRAWINGS.
- 8. PROVIDE ALL COLUMN BASE ANCHORS, BEAM SEATS, HANGERS, HURRICANE AND FRAMING ANCHORS, ETC. AS MAY BE REQUIRED, BY SIMPSON OR EQUAL.
- 9. ALL INDICATED FLOOR & ROOF TRUSSES, LVL BEAMS & HEADERS ARE TO BE PRE-ENGINEERED BY THE MANUFACTURER. ALSO, ALL STRUCTURAL ACCESSORIES SUCH AS PLATES, BRACING, BRIDGING, ETC., ARE TO BE PRE-ENGINEERED AND PROVIDED BY SAME. LVL'S SHALL BE FB=2925 PSI MINIMUM OR BETTER.
- 10. SIMPSON HANGERS OR EQUAL FOR JOISTS, RAFTERS, OR TRUSSES SHALL BE PROVIDED AT ALL BEAMS CALLED OUT AS "FLUSH" AND AT ALL 'GIRDER TRUSSES'.
- 11. ROOF TRUSSES AND RAFTERS TO SUPPORTING TOP PLATES OR BEAMS USE UPLIFT ANCHORS (HURRICANE TIES) EQUAL TO SIMPSON MODEL H2.5 INSTALLED PER MANUFACTURER'S REQUIREMENTS.
- 12. INSTALL ONE LINE OF SOLID BLOCKING OR CROSS BRIDGING AT 8'-0" O.C. FOR ALL FLOOR AND CEILING JOISTS.
- 13. INSTALL ONE LINE OF SOLID LATERAL BLOCKING AT MID-HEIGHT OF LOAD BEARING STUDWALLS THAT ARE NOT SHEATHED EACH SIDE.
- 14. LUMBER IN CONTACT WITH CONCRETE OR MASONRY SHALL BE PRESSURE TREATED DECAY RESISTANT. FASTENERS AND HARDWARE FOR TREATED WOOD SHALL BE GALVANIZED OR STAINLESS STEEL.

BRICK LINTEL NOTES:

- 1. PROVIDE LINTELS OVER ALL OPENINGS IN MASONRY WALLS AND BRICK VENEER. REFER TO ARCHITECTURAL AND MECHANICAL DRAWINGS FOR SIZES AND LOCATIONS OF OPENINGS, AND FOR STANDARD LINTELS, USE THE APPROPRIATE LINTEL FROM THE SCHEDULE BELOW.
- 2. PROVIDE ONE ANGLE FOR EACH 4" OF WALL THICKNESS, AND USE 6" MINIMUM BEARING EACH END. FOR BEAM LINTELS, STOP BOTTOM PLATE 1/8" SHORT OF JAMBS, AND USE 8" MINIMUM BEARING EACH END.

MASONRY ROUGH OPENING TO 4'-0" L 3-1/2 X 3-1/2 X 5/16 4'-1" TO 5'-6" L 4 X 3-1/2 X 5/16 LLV 5'-7" TO 6'-6" L 5 X 3-1/2 X 5/16 LLV 6'-7" TO 9'-0" L 6 X 3-1/2 X 5/16 LLV 9'-1" TO 16'-0" L 6 X 3-1/2 X 5/16 LLV w/ 3/8" LAG BOLTS EVERY 48" O.C.




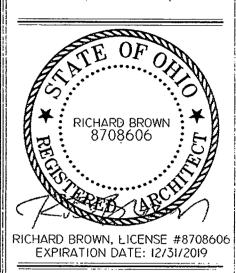

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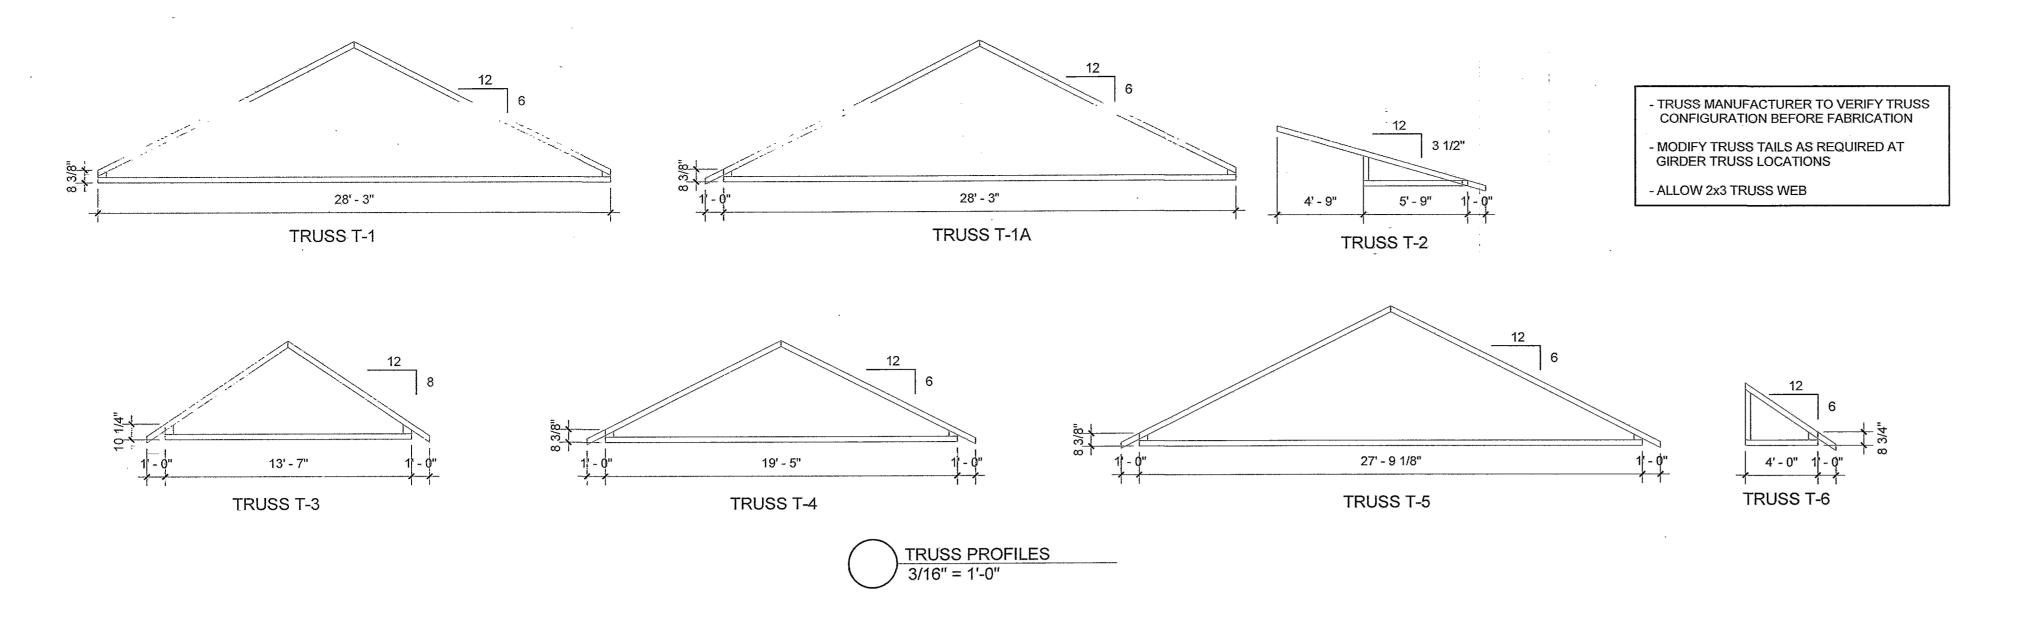
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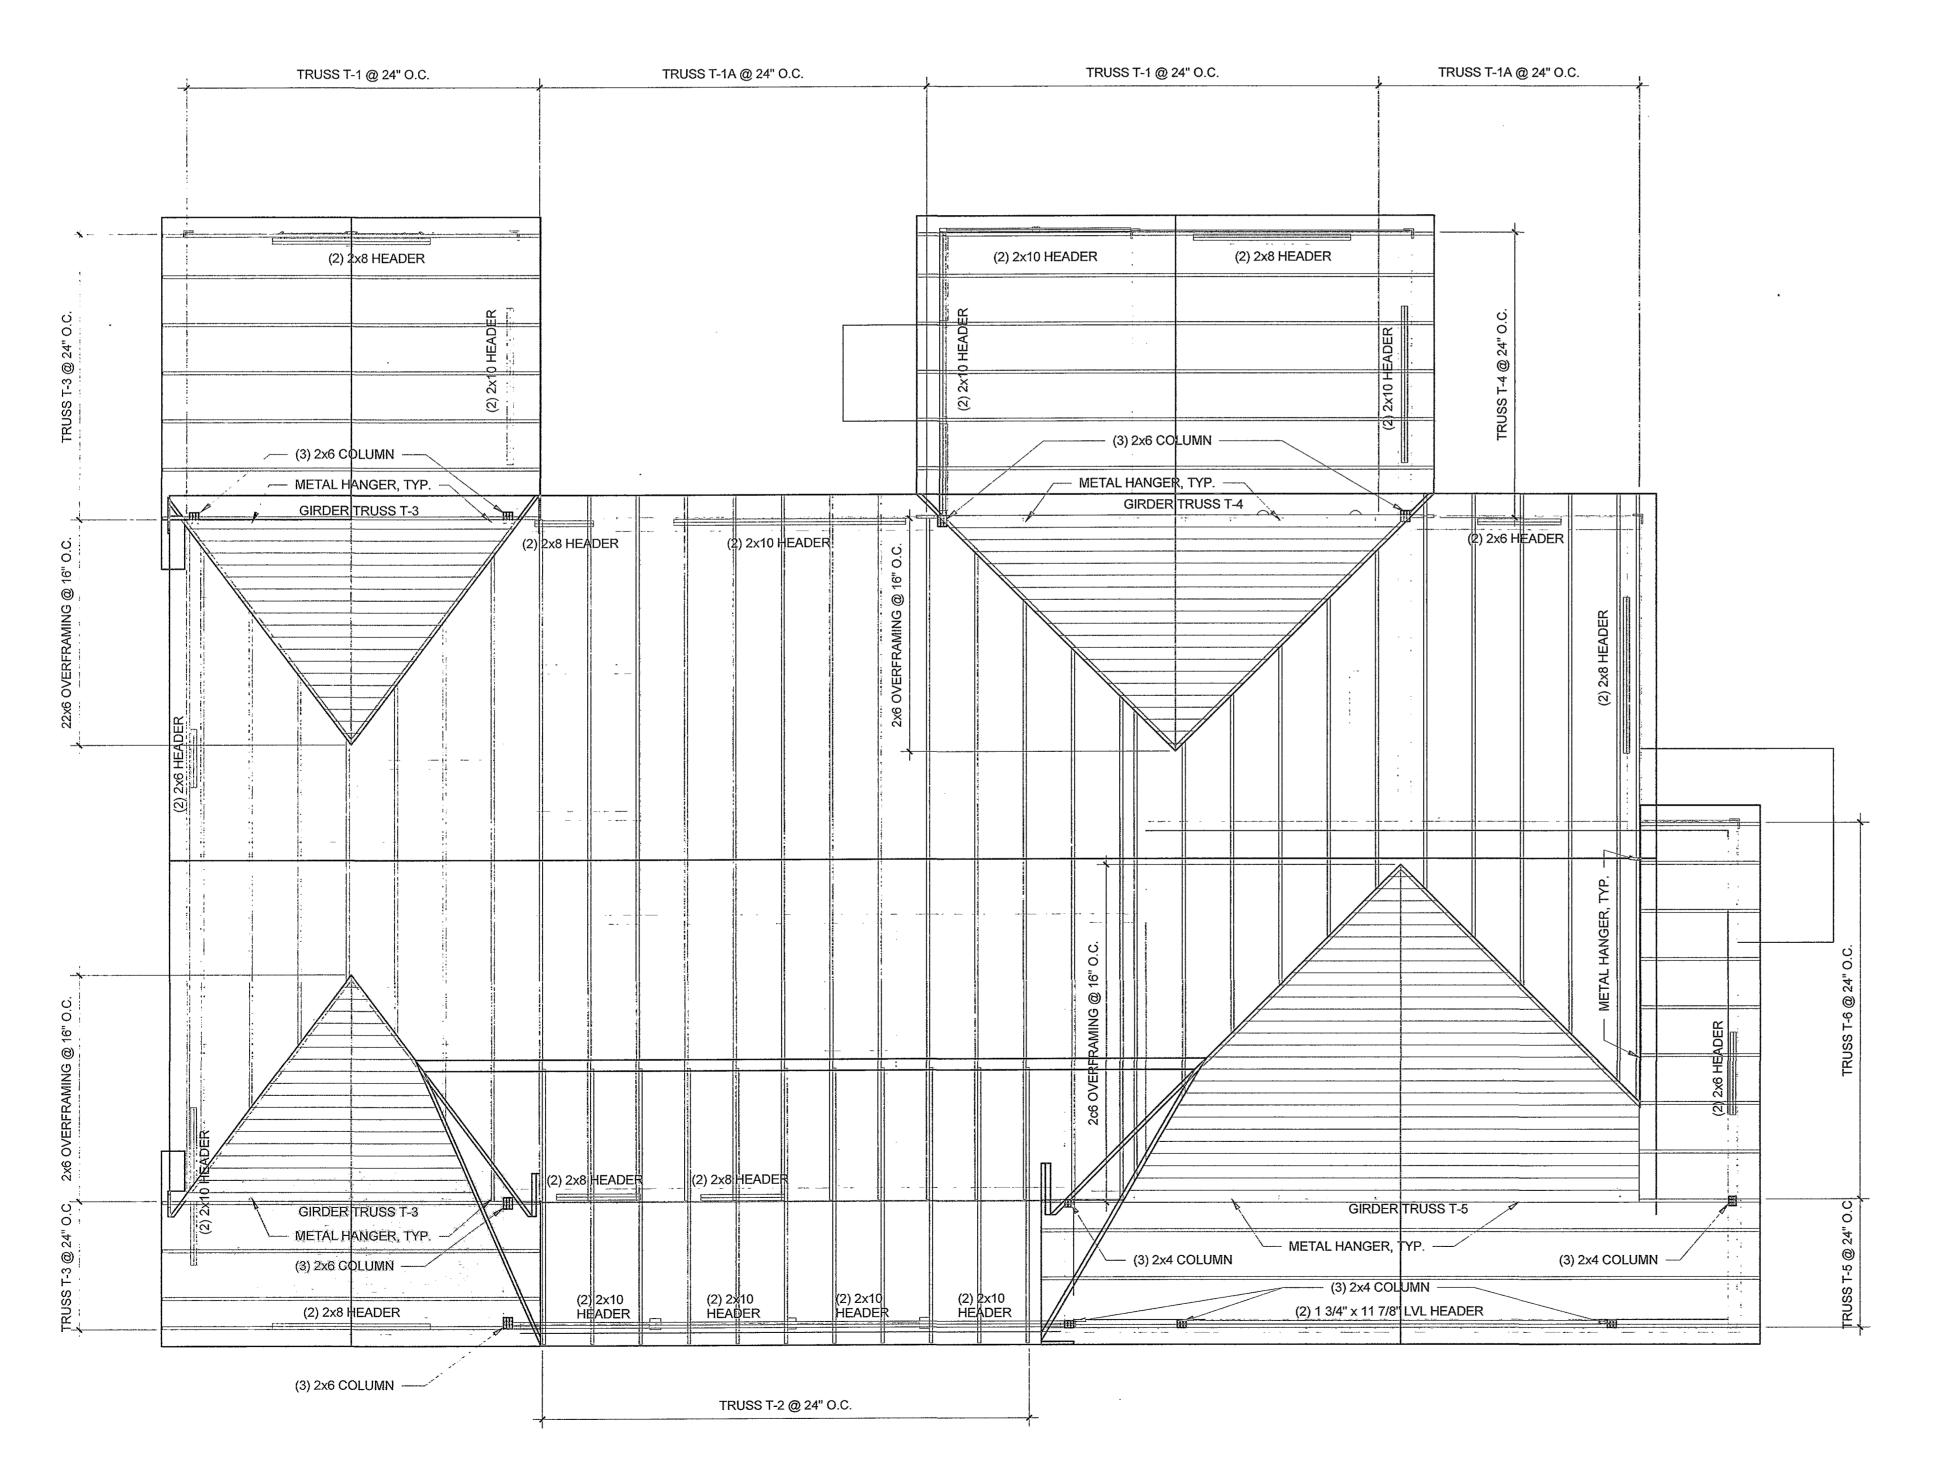


DATE: 4/30/19 DRAWN: DCP CHECKED: RBB

> DRAWING NAME: FIRST FLOOR FRAMING 7 of 13
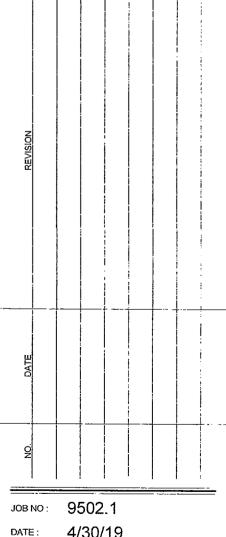
> > A-5





ROOF FRAMING PLAN
1/4" = 1'-0"

GENERAL FRAMING NOTES:

1. ALL STRUCTURAL FRAMING LUMBER SHALL BE SPRUCE PINE FIR (SPF) NO. 2, FB=1000 PSI OR BETTER, OR AS PRE-ENGINEERED. ALL EXPOSED DECKING LUMBER SHALL BE "PRESSURE TREATED"

DESIGN LOADS USED:

ROOF (LIVE & DEAD) 40 PSF FLOOR (LIVE & DEAD) 55 PSF DECK (LIVE & DEAD)

CEILING (LIVE ONLY) 20 PSF (ATTIC SPACES WITHOUT STAIRS)


WIND (LIVE ONLY) 90 MPH

- 3. ALL MUDSILL PLATES SHALL BE PRESSURE TREATED AND SET ON CONTINUOUS SILL SEALER.
- 4. ALL EXTERIOR WALL CONSTRUCTION SHALL BE 2X6 STUDS AT 16" O.C., WITH R-21 MINIMUM INSULATION AND 4 MIL POLYETHYLENE VAPOR BARRIER TO THE INSIDE FACE OF STUDS, WITH 1/2" OSB SHEATHING AND 'TYVEK HOUSEWRAP' TO OUTSIDE FACE OF STUDS.
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- 12. INSTALL ONE LINE OF SOLID BLOCKING OR CROSS BRIDGING AT 8'-0" O.C. FOR ALL FLOOR AND CEILING JOISTS.
- 13. INSTALL ONE LINE OF SOLID LATERAL BLOCKING AT MID-HEIGHT OF LOAD BEARING STUDWALLS THAT ARE NOT SHEATHED EACH SIDE.
- 14. LUMBER IN CONTACT WITH CONCRETE OR MASONRY SHALL BE PRESSURE TREATED DECAY RESISTANT. FASTENERS AND HARDWARE FOR TREATED WOOD SHALL BE GALVANIZED OR STAINLESS STEEL.


BRICK LINTEL NOTES:

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MASONRY ROUGH OPENING <u>SECTION</u> L 3-1/2 X 3-1/2 X 5/16 TO 4'-0" 4'-1" TO 5'-6" L 4 X 3-1/2 X 5/16 LLV 5'-7" TO 6'-6" L 5 X 3-1/2 X 5/16 LLV 6'-7" TO 9'-0" L 6 X 3-1/2 X 5/16 LLV 9'-1" TO 16'-0" L 6 X 3-1/2 X 5/16 LLV w/ 3/8" LAG BOLTS EVERY 48" O.C.

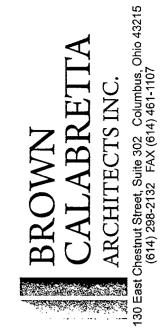

VOL 70 PG 8

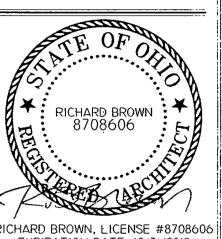

RICHARD BROWN, LICENSE #8708606 EXPIRATION DATE: 12/31/2019


O LIVING ON CATAWBA OHIO VINEYARD


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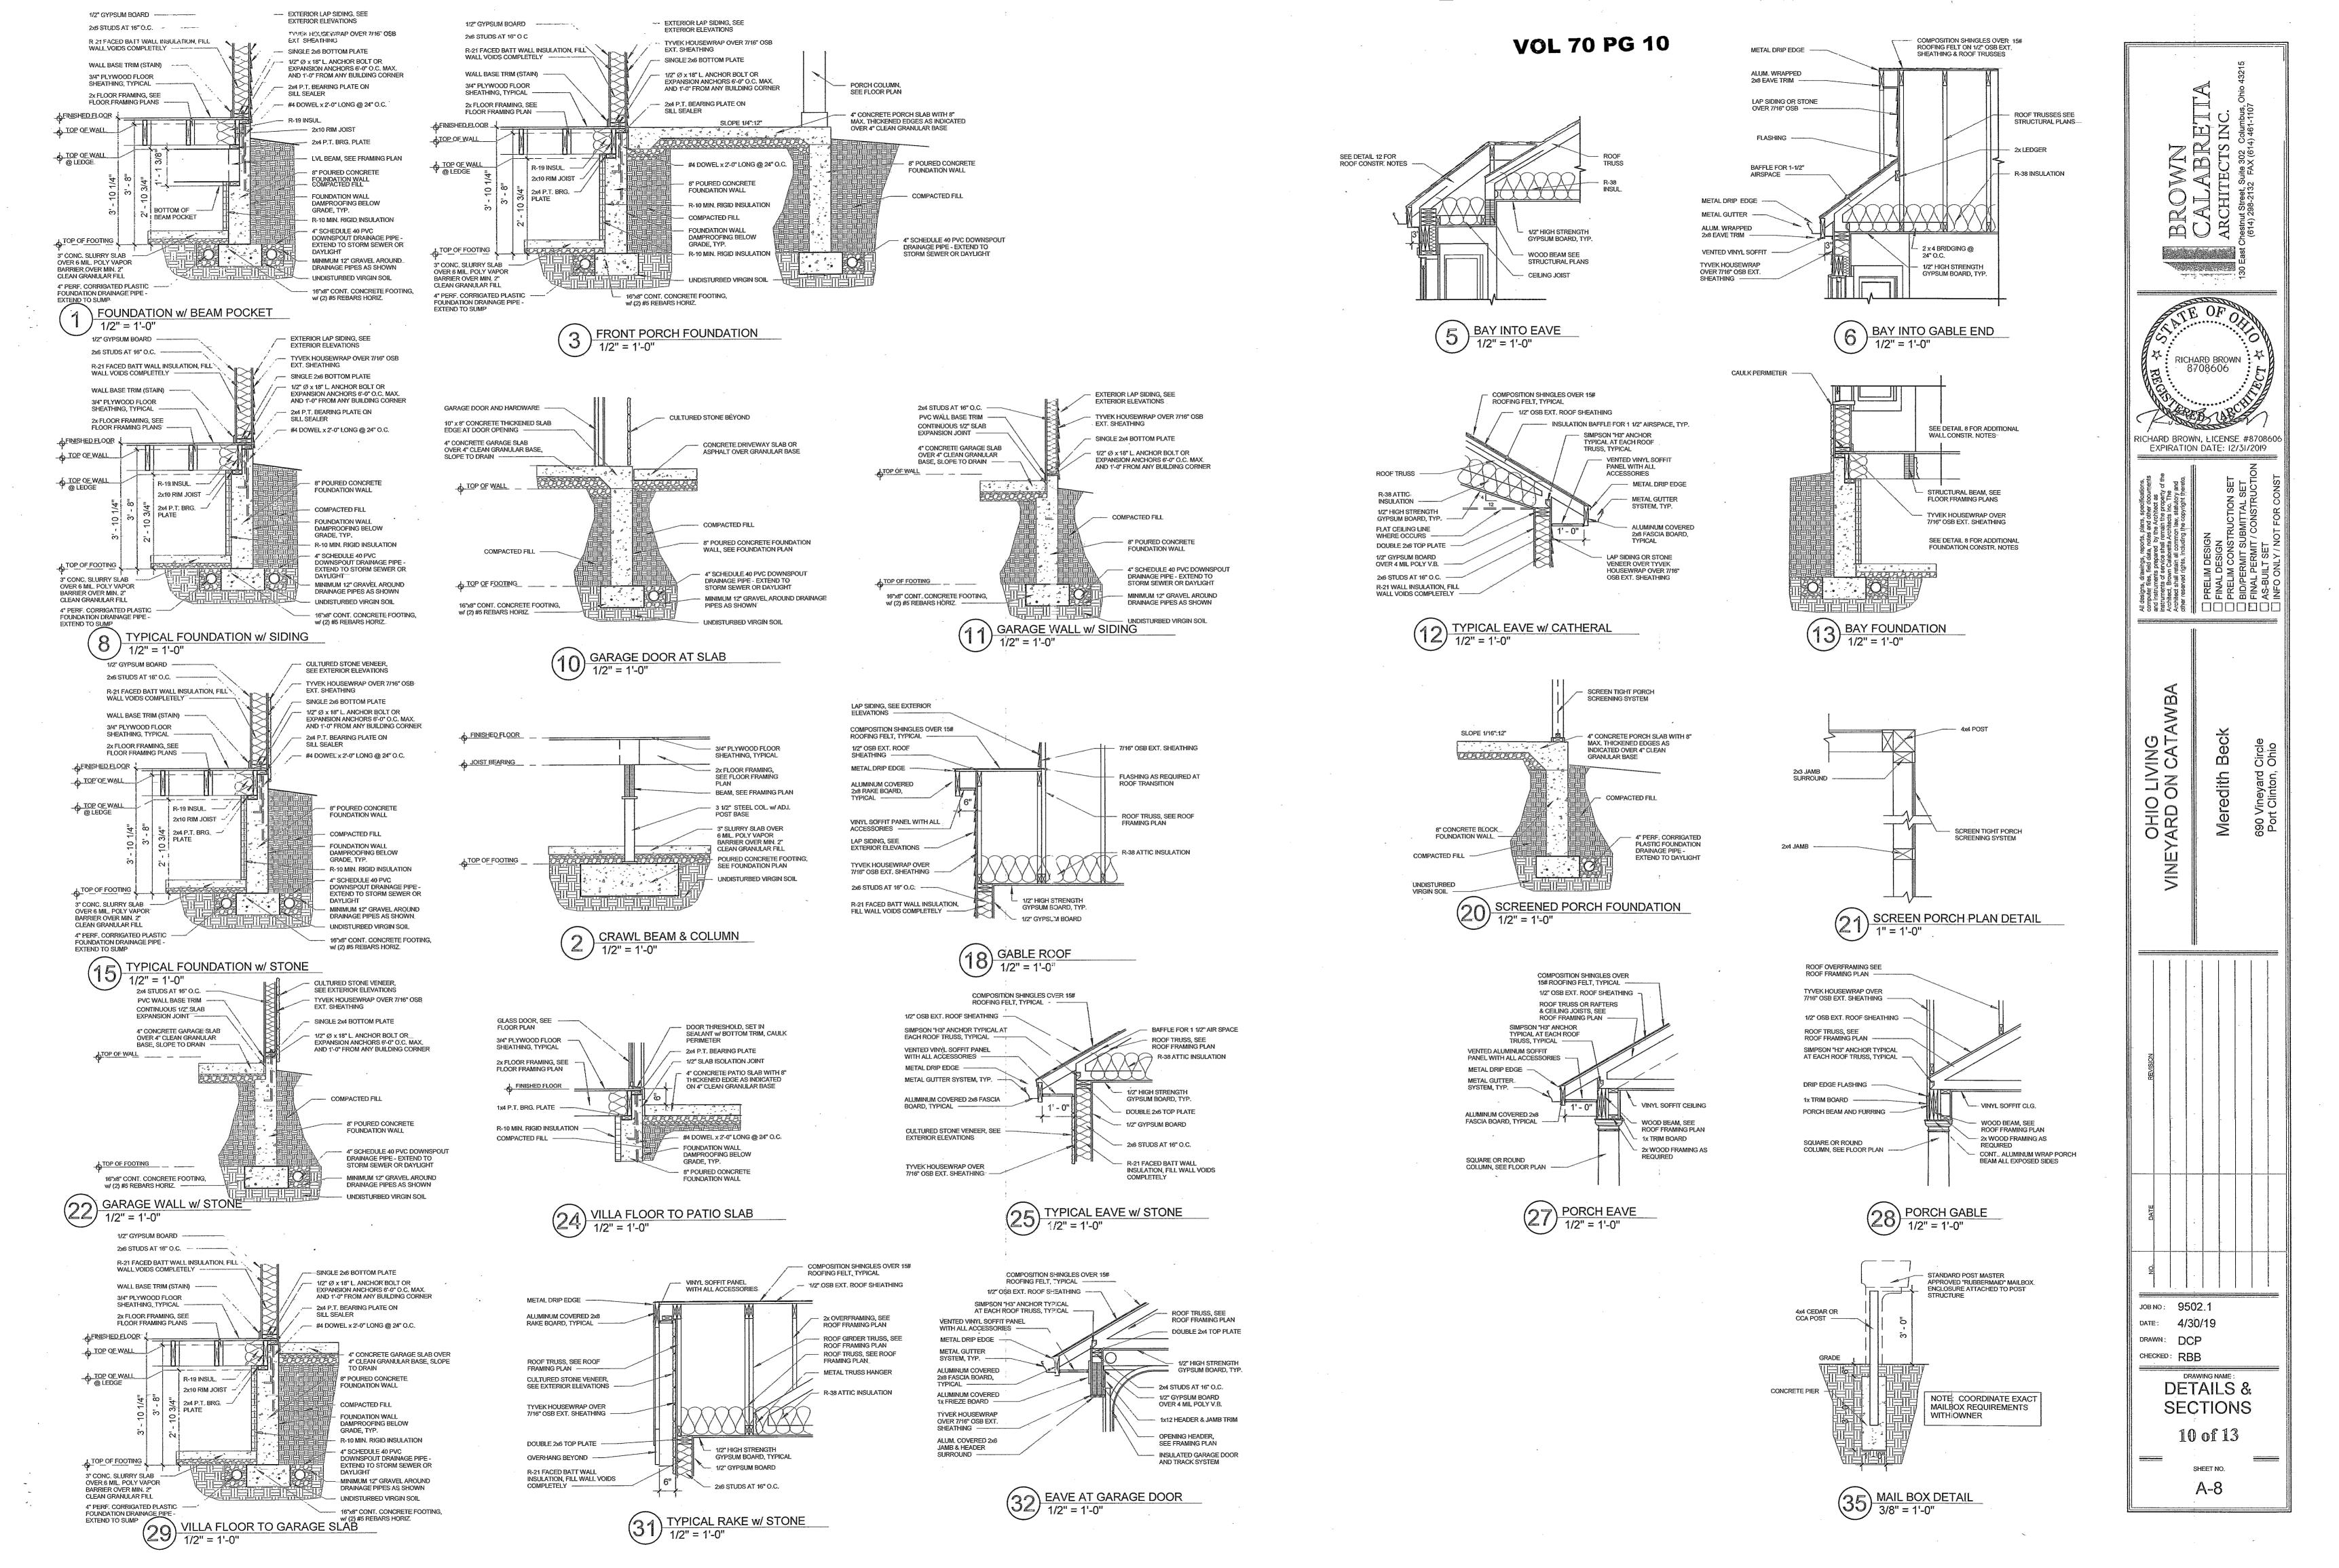
DATE: 4/30/19 DRAWN: DCP CHECKED: RBB DRAWING NAME: **ROOF FRAMING**


> PLAN 8 of 13

A-6



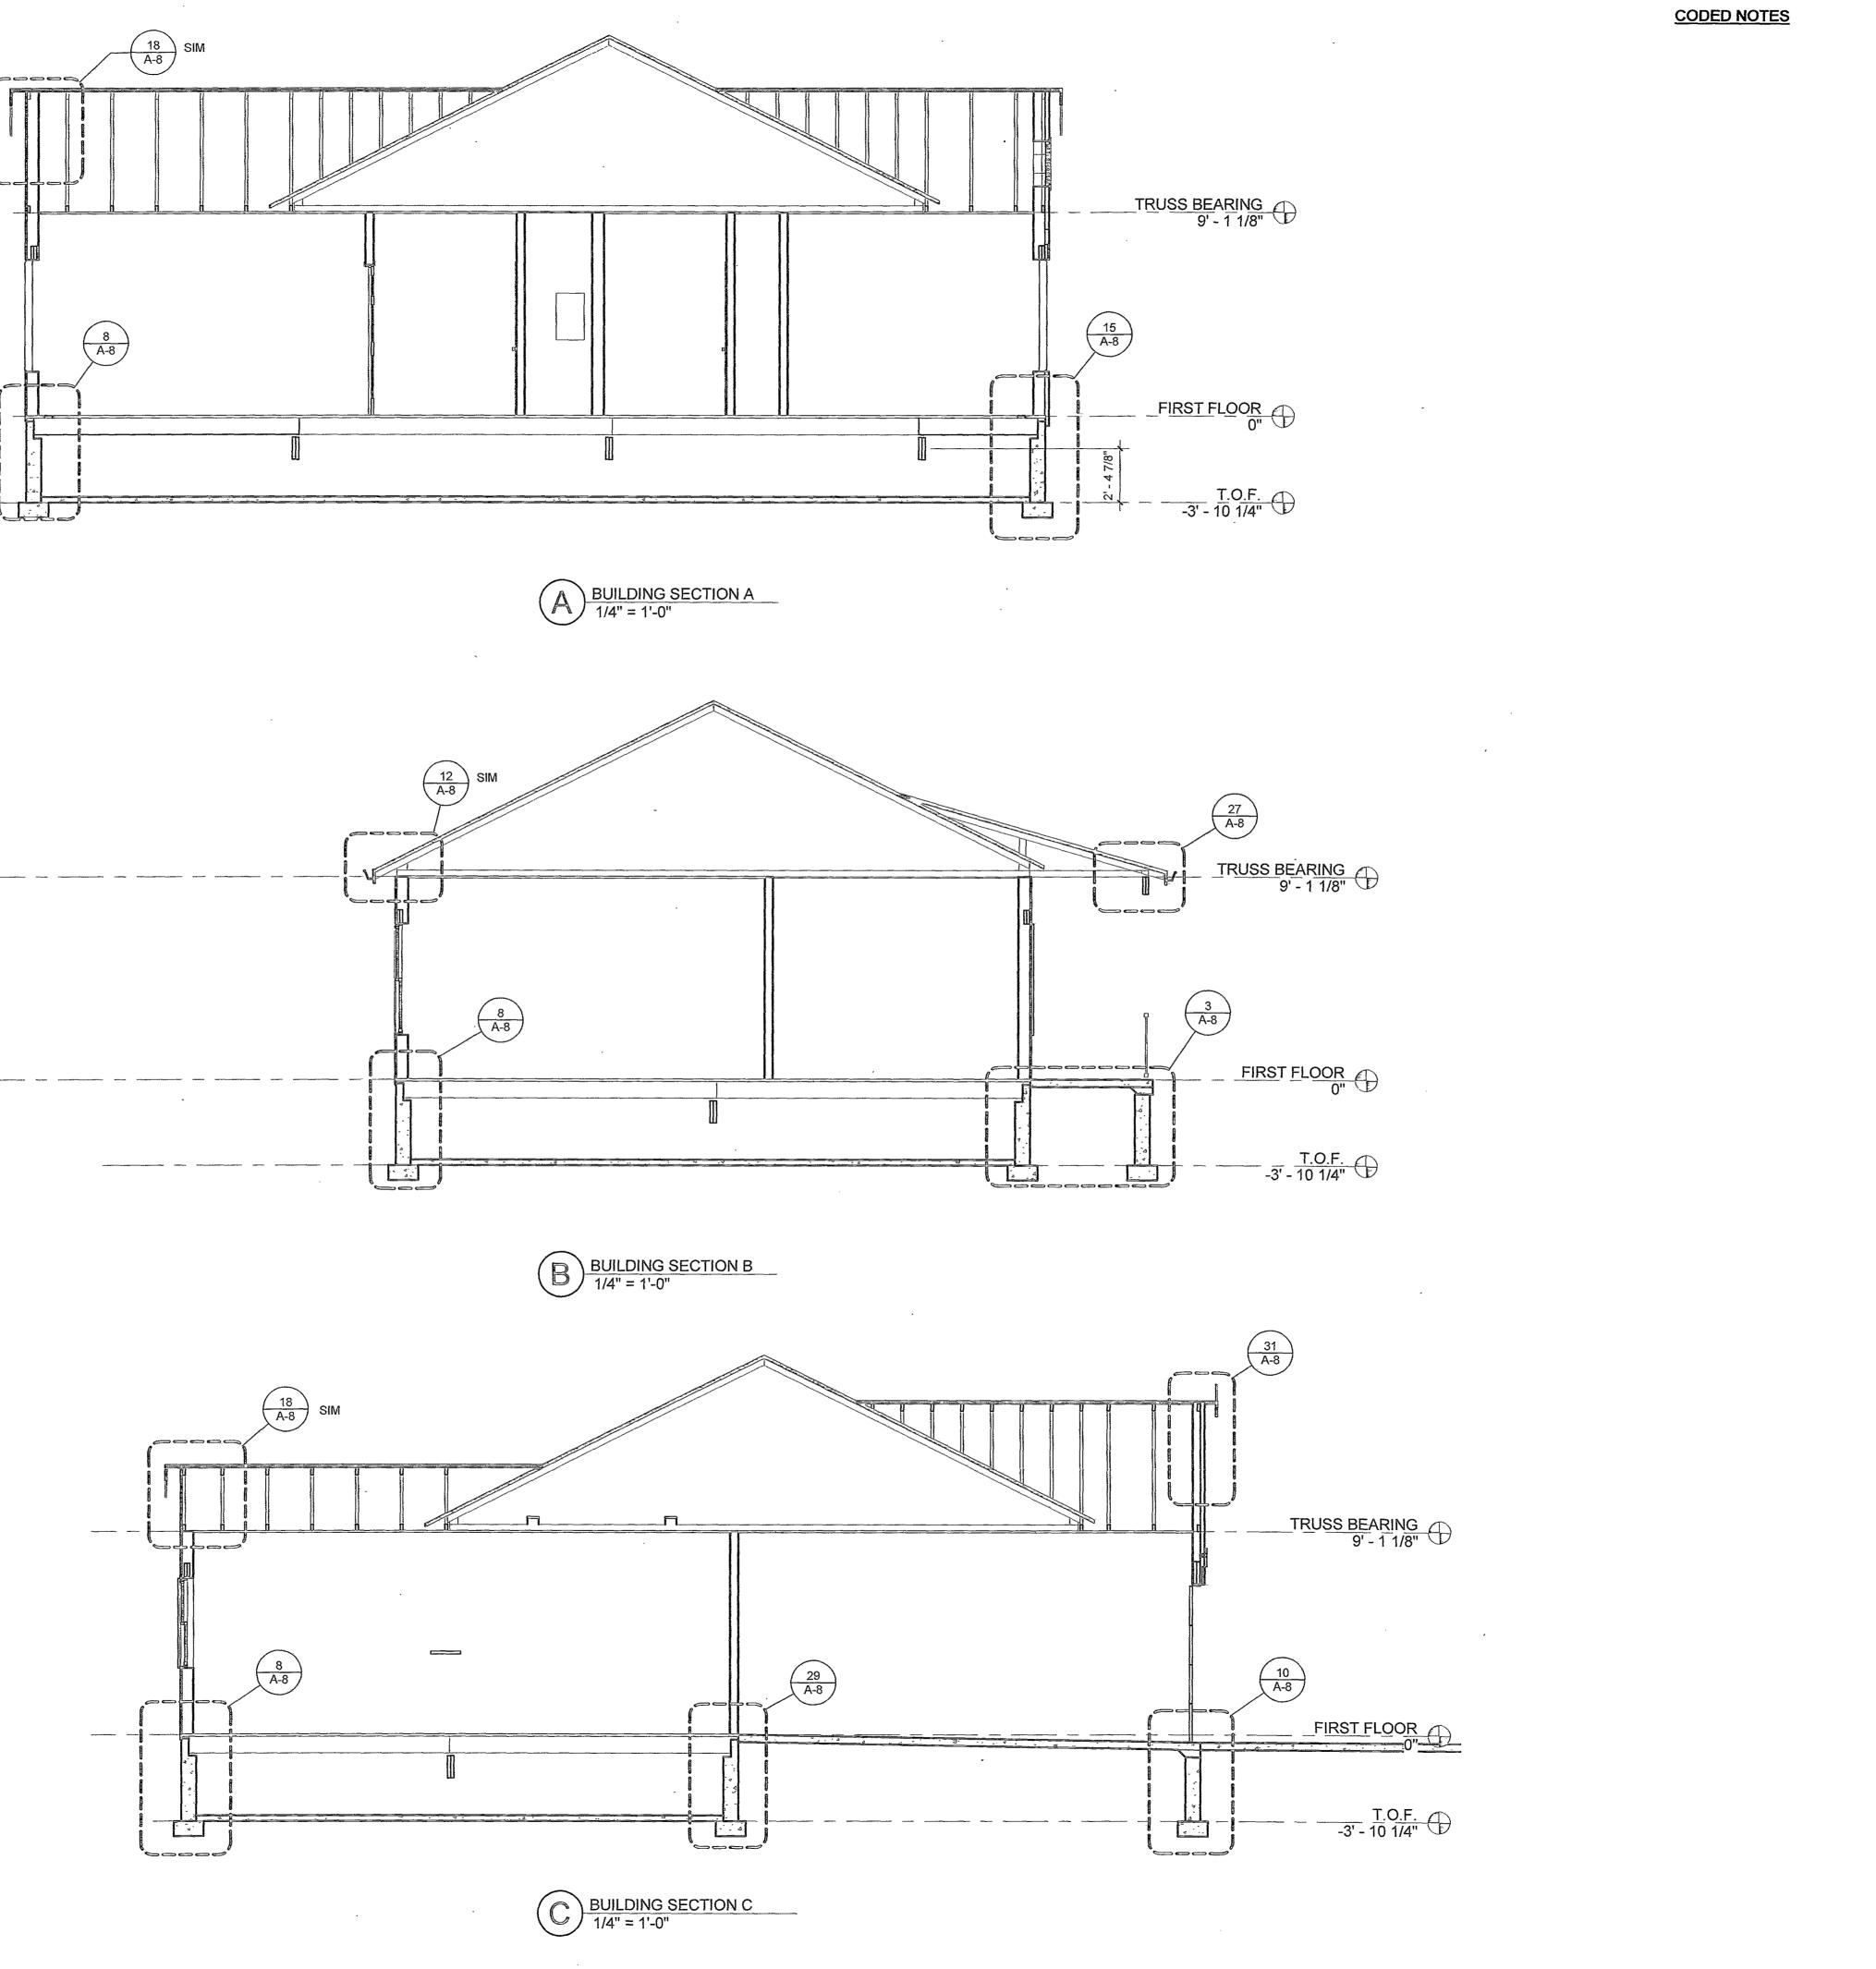

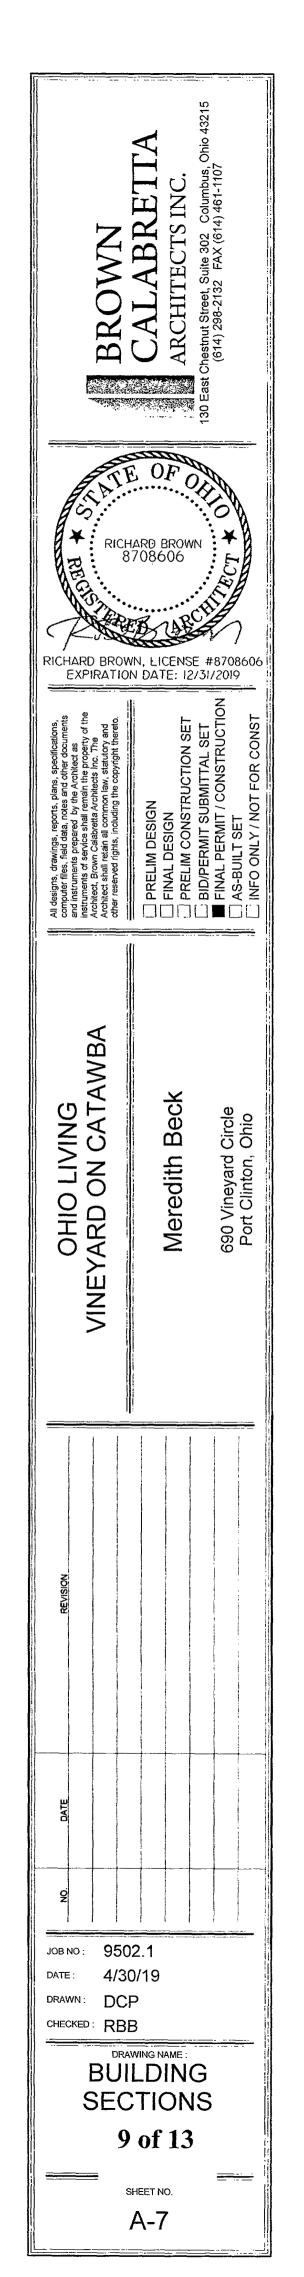

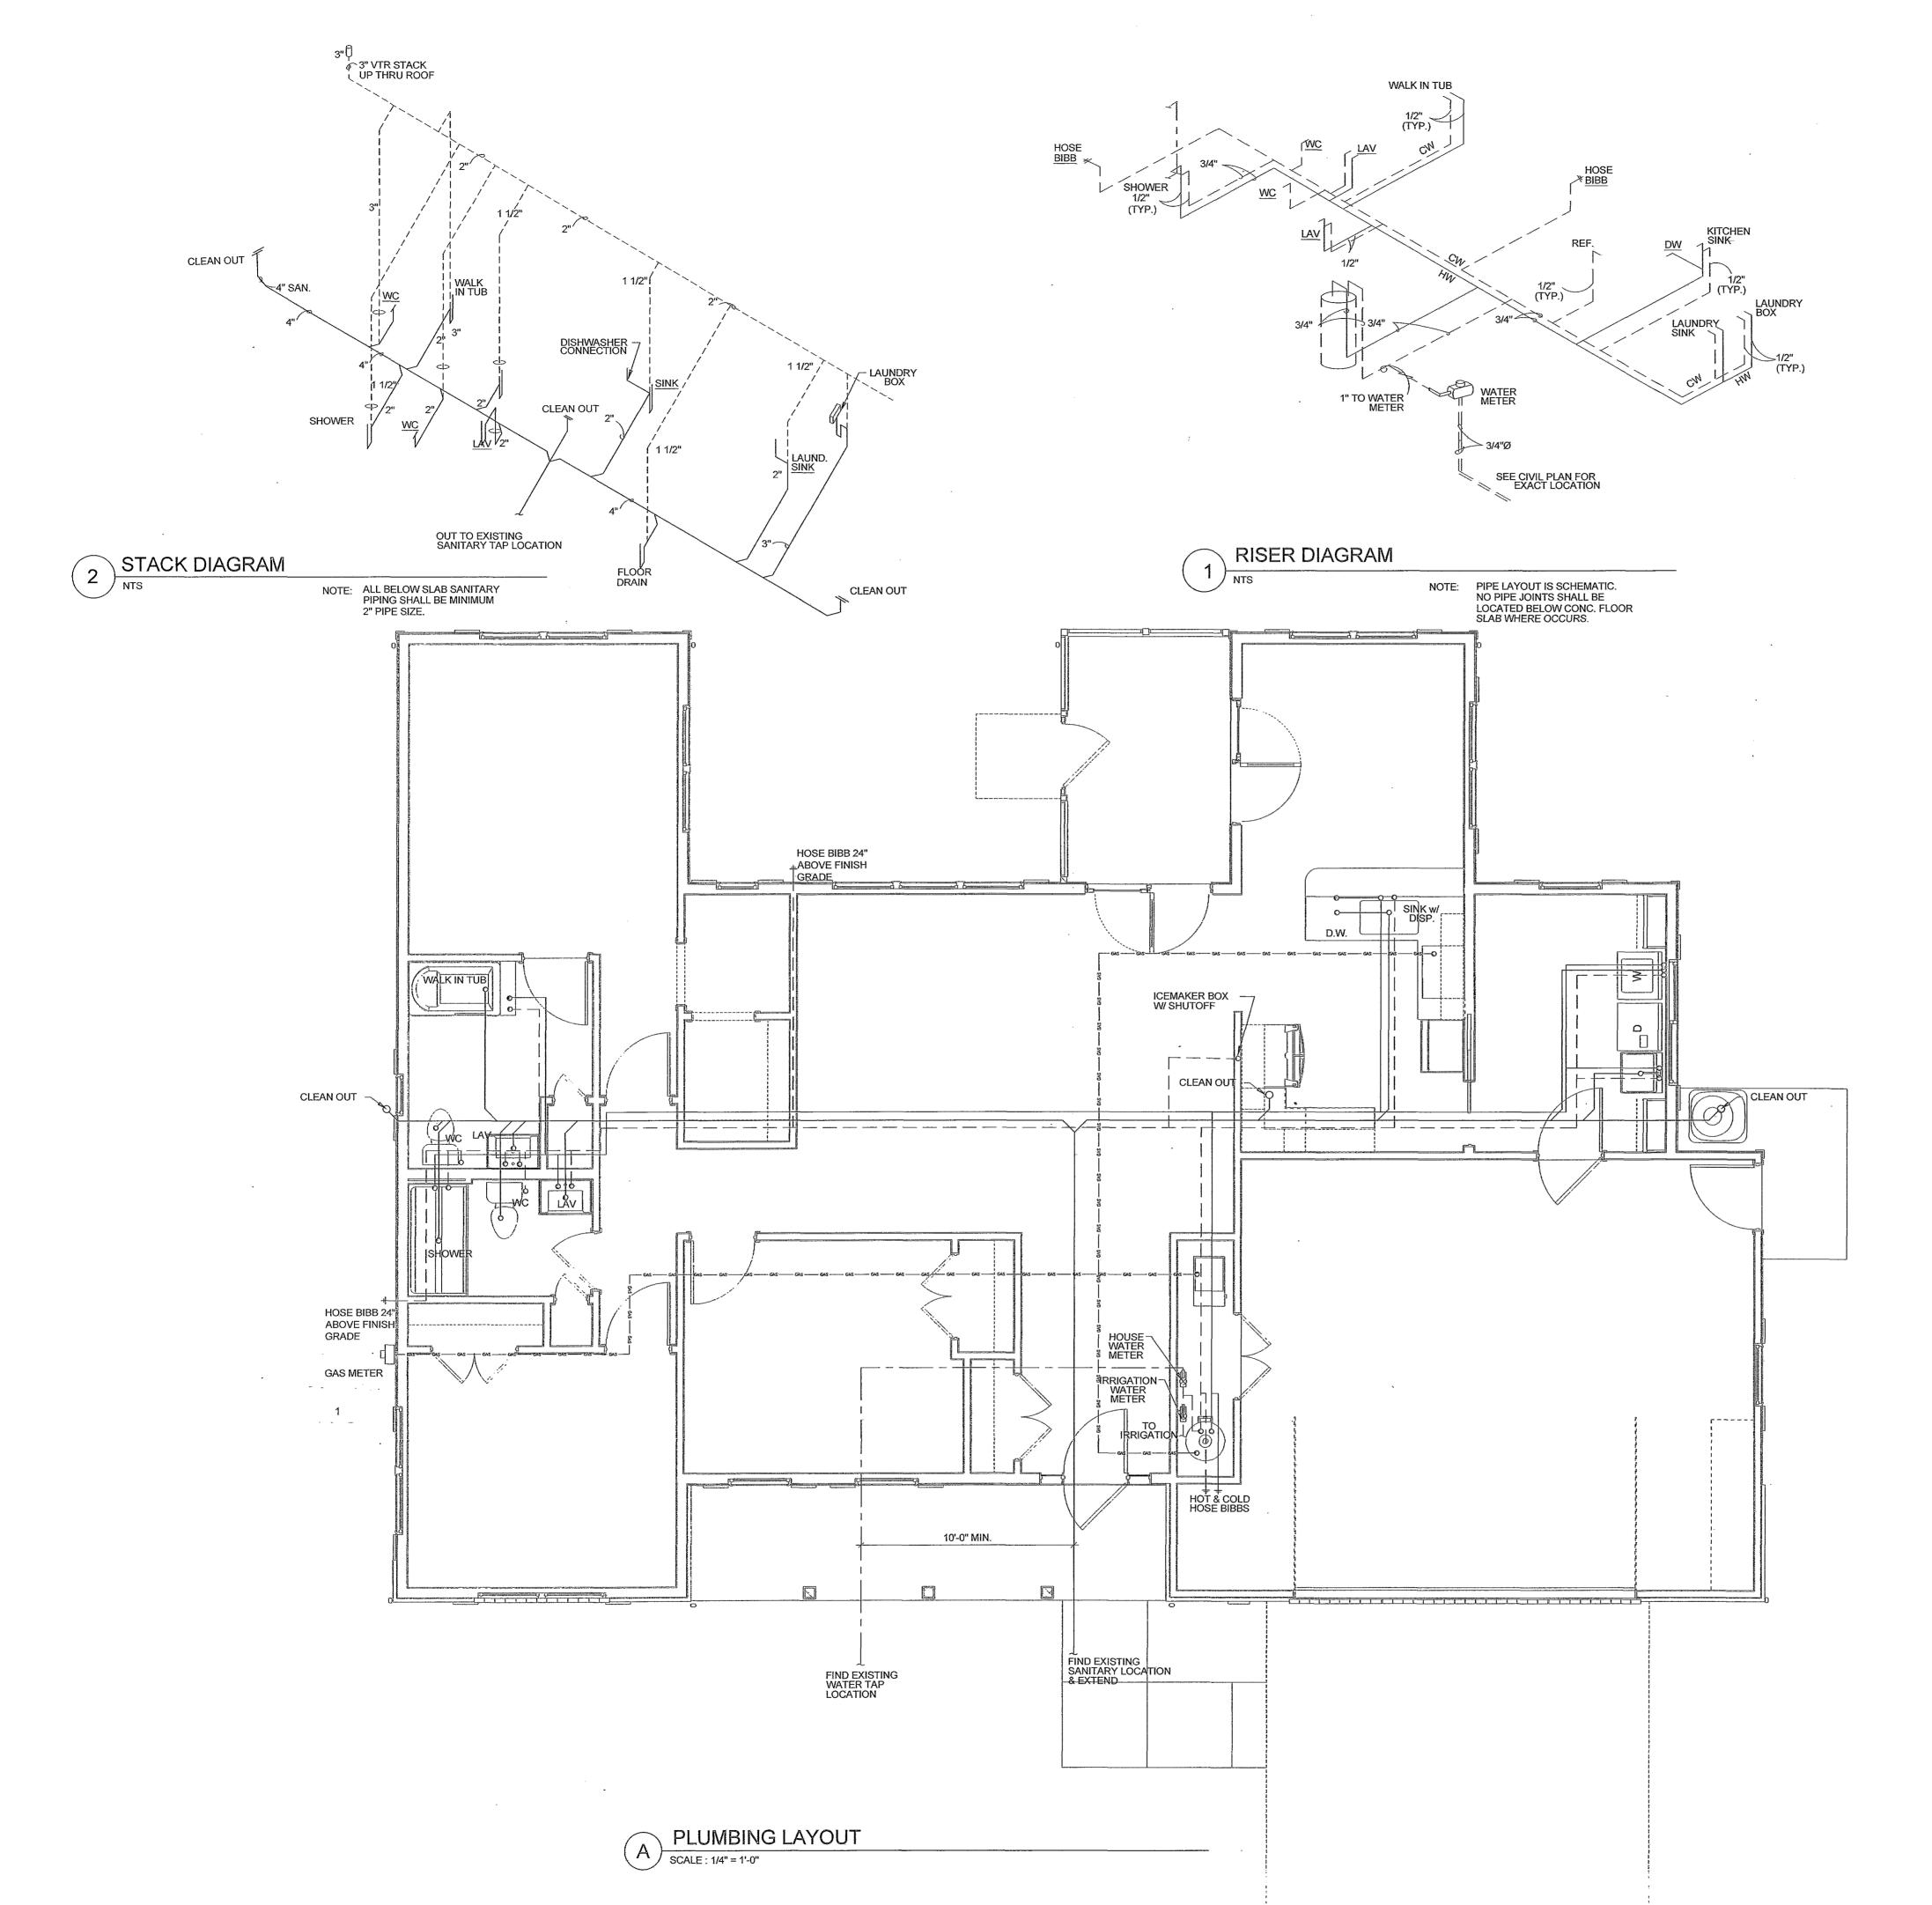

GENERAL PLUMBING NOTES:

 ALL NEW WORK SHALL CONFORM TO CURRENT OHIO BUILDING CODES, OHIO PLUMBING CODE, COUNTY BOARD OF HEALTH REGULATIONS, AND ANY OTHER APPLICABLE CODES OR REQUIREMENTS.
PLUMBING CONTRACTOR SHALL VERIFY ALL EXISTING UTILITIES,
ACQUIRE AND PAY FOR ALL PERMITS, CERTFICATES, AND
INSPECTIONS, AND PERFORM ALL WORK FOR INSTALLATION OF GAS,
WATER, AND SEWER UTILITIES.

2. COORDINATE ALL WORK WITH OTHER TRADES THROUGH THE GENERAL CONTRACTOR AND NOTIFY THE ARCHITECT OF ANY MAJOR INSTALLATION

PLUMBING CONTRACTOR SHALL NOT CUT OR DRILL THROUGH ANY STRUCTURAL MEMBER OR ELEMENT WITHOUT CONTACTING THE ARCHITECT FOR APPROVAL AND REQUIREMENTS.

4. ALL HOSE BIBBS SHALL BE VACUUM BREAKER TYPE (12" STEM MINIMUM). ALL HOSE BIBBS SHALL HAVE SHUT-OFF VALVES INSIDE BUILDING.

5. PROVIDE UNIONS AND UPSTREAM SHUT-OFF VALVE AT WATER HEATER, WATER METER, AND OTHER ITEMS OF EQUIPMENT WHICH CAN BE REMOVED OR REPLACED.

6. RUN RELIEF LINE FROM WATER HEATER TO WITHIN 2" OF FLOOR DRAIN. 7. RUN CONDENSATE FROM HVAC EQUIPMENT FULL SIZE TO FLOOR DRAIN.

PLUMBING FIXTURE SCHEDULE

UTILITY SINK


EXTERIOR HOSE BIBS

KITCHEN SINK KOHLER IRON TONES FARM SINK K 57072 w/ DELTA FAUCET 450-WF AND DAYTON D1125 STRAINER ACCEPTABLE SUBSTITUTES: KOHLER, ELKAY, MOEN KOHLER 30" PEDESTAL LAVITORY LAVATORY w/ DELTA FAUCET 520-WFMPU ACCEPTABLE SUBSTITUTES: KOHLER, PENNINGTON, AMERICAN STANDARD WATER CLOSET KOHLER 'WELLWORTH' OR 'HIGHLINE' FOR HC TOILETS ACCEPTABLE SUBSTITUTES: BRIGGS, PENNINGTON, AMERICAN STANDARD TOILET SEAT TO BE OLSONITE 100 - ACCEPTABLE SEAT SUBSTITUTES: BEMIS OR CENTACO SHOWER ENCLOSURE AQUATICS 1603 TSCB w/ DELTA 1524 FAUCET SET & RP7245 SLIDE/ROD SET. ACCEPTABLE SUBSTITUTE MANUFACTURER IS AQUAGLASS, AQUATICBATH, MAXXON, MOEN. WALK IN TUB SAFE STEP MODEL SELECTED BY RESIDENT. ACCEPTABLE SUBSTITUTE MANUFACTURER IS AMERICAN STANDARD, KOHLER, JACUZZI. WATER HEATER 60 GALLON WATER HEATER w/ RECIRC. PUMP STANDARD USE, RUUDGLAS ENERGY MISER M40 - ACCEPTABLE SUBSTITUTES: SEARS, RHEEM, A.O. SMITH, STATE, MOR-FLO. STAND-BY LOSS SHALL NOT EXCEED 4.5 W/SF OF TANK SURFACE COMPLY WITH ASHRAE 90A-80.

> LAUNDRY ROOMS: AQUAGLASS ALT-WA W/ DELTA DUAL LEVER UTILITY FAUCET

3/4" FROST PROOF TYPE WITH VACUUM BREAKER

MOUNTED AT 24" ABOVE FINISH GRADE BY JOSAM, WADE, WOODFORD, ZURN OR MANSFIELD.

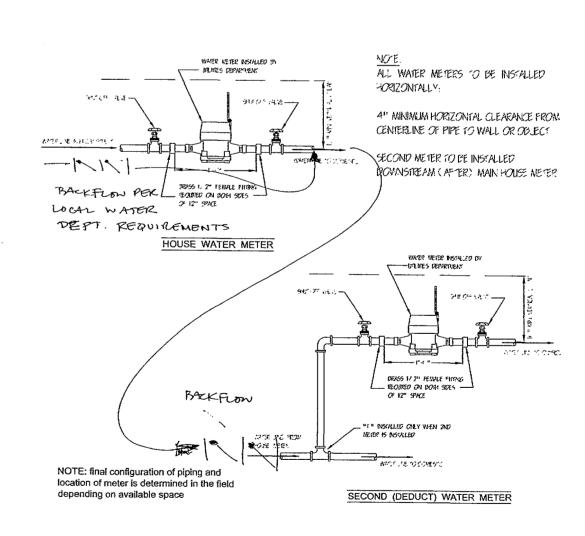

METER & BACKFLOW DIAGRAM SCALE : 1/4" = 1'-0"



RICHARD BROWN, LICENSE #8708606 EXPIRATION DATE: 12/31/2019.


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JOB NO: 9502.1

DATE: 4/30/19 CHECKED: rbb

> DRAWING NAME: **PLUMBING**

11 of 13

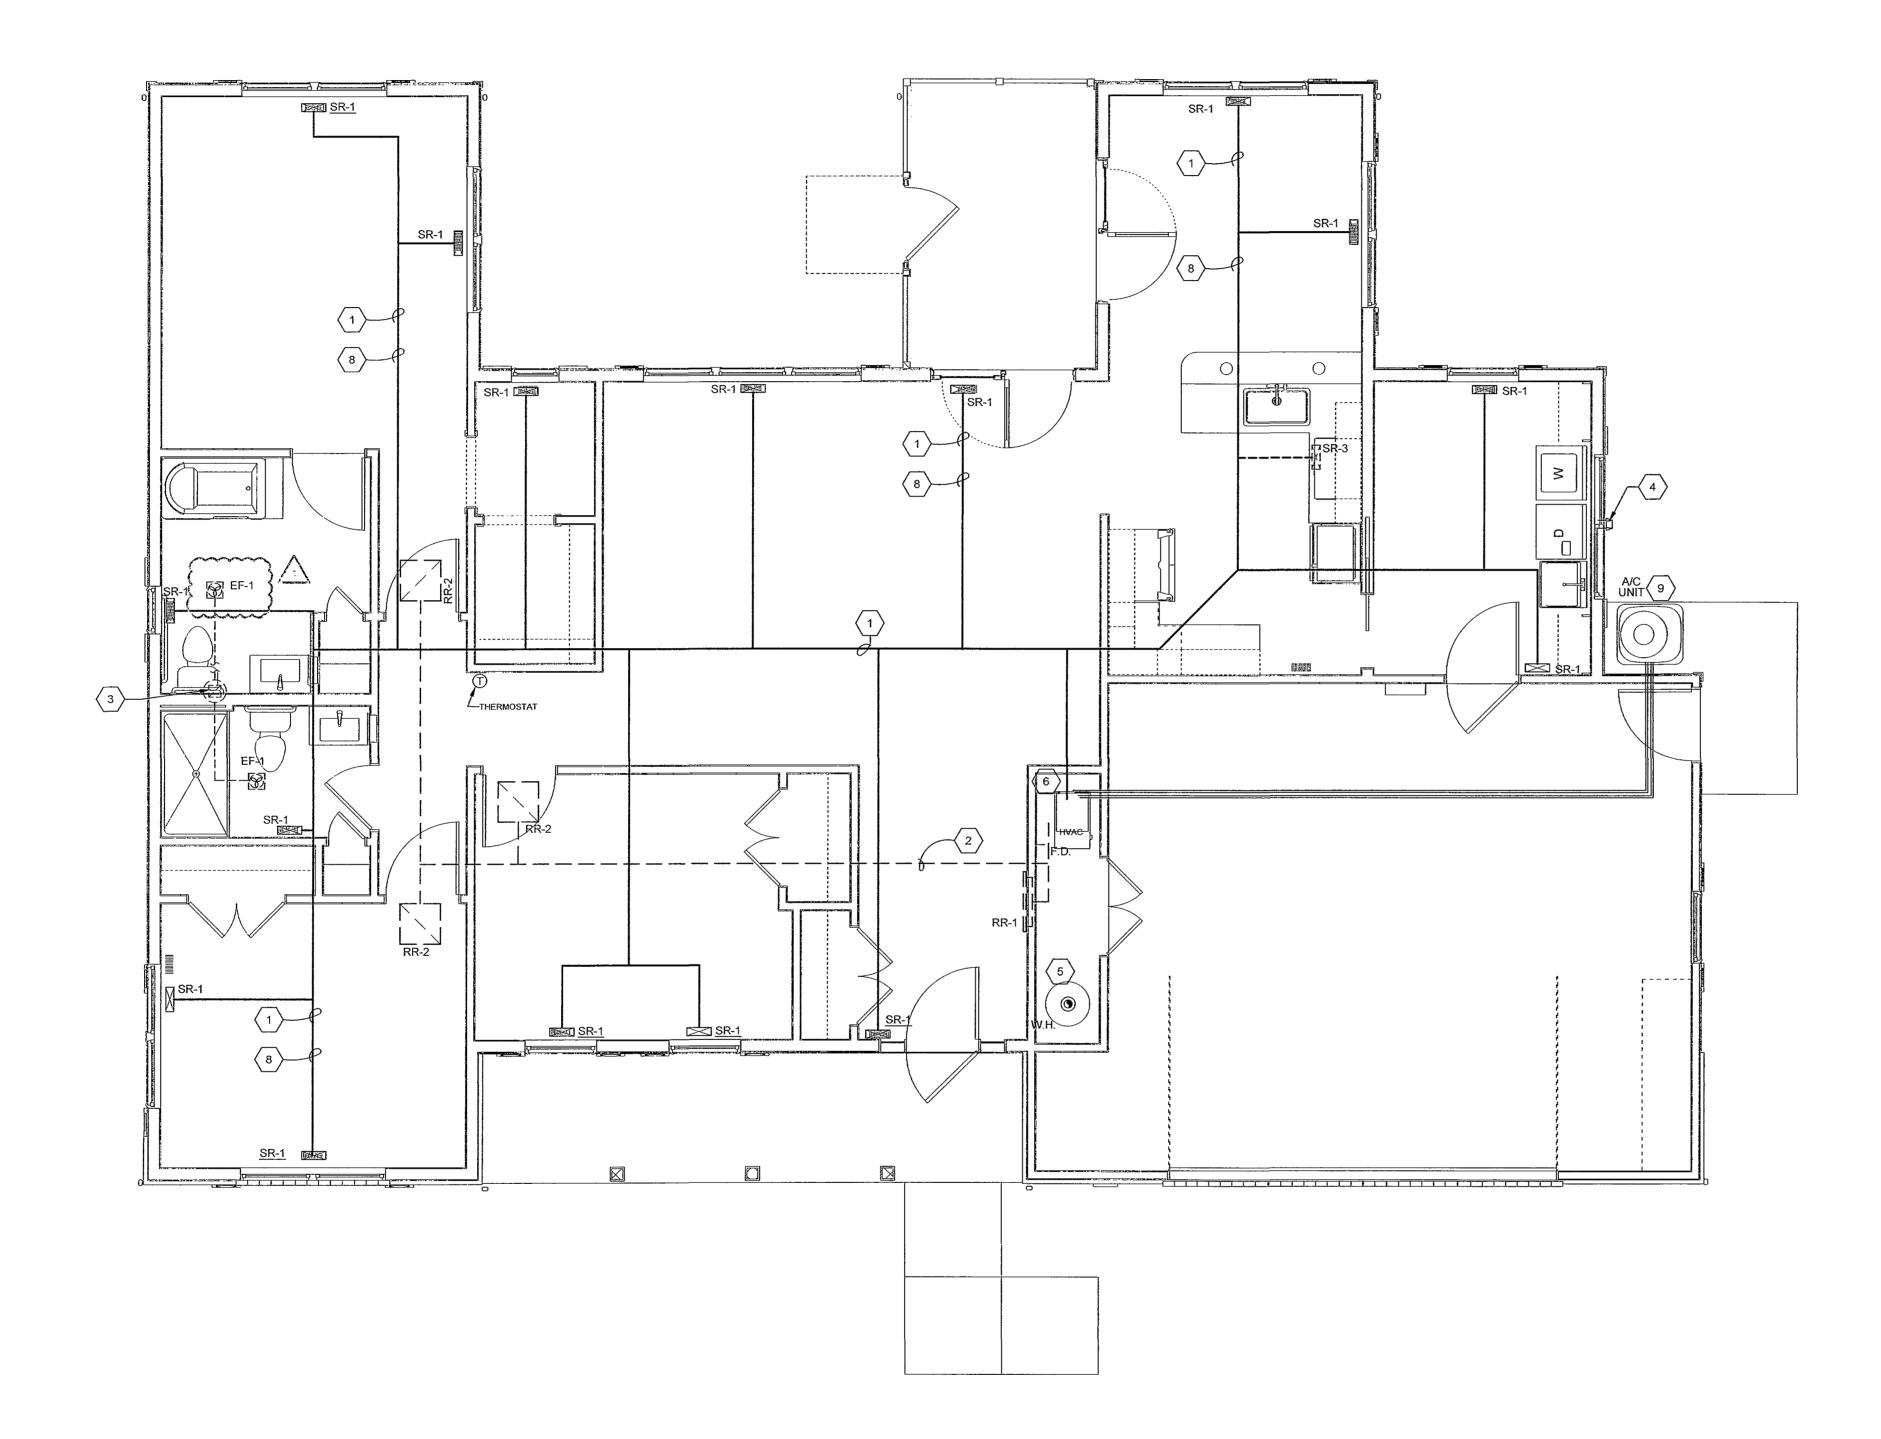


MECHANICAL LAYOUT


SCALE: 1/4" = 1'-0"


VOL 70 PG 12

MARK	TYPE OF UNIT	CHARACTERISTICS	MANUFACTURERS
<u>AHU-1</u>	FURNACE	TO BE SIZED BY HVAC CONTRACTOR ON A PER VILLA BASIS SEE SPECIFICATIONS	ARMSTRONG CARRIER RHEEM
COND-1	CONDENSING UNIT	TO BE SIZED BY HVAC CONTRACTOR ON A PER VILLA BASIS SEE SPECIFICATIONS	ARMSTRONG CARRIER RHEEM
<u>EF-1</u>	BATH EXHAUST FAN/LIGHT	MIN. CFM = 70	NUTONE MODEL #669 FASCO BROAN
<u>EF-2</u>	1500 WATT HEATER/ EXHAUST FAN/LIGHT	MIN. CFM = 70	NUTONE MODEL #665
SR-1 SR-2 SR-3	FLOOR SUPPLY REGISTER TOE-KICK SUPPLY REGISTER CRAWL SPACE SUPPLY	3-WAY DEFLECTION, STEEL CONSTRUCTION, OFF-WHITE FINISH, ADJUSTABLE DAMPER, MOUNTING GASKET, 4"x12"	HART & COOLEY LIMA J&J REGISTER
RR-1 RR-2	SIDEWALL RETURN GRILLE CEILING RETURN GRILLE	STEEL CONSTRUCTION, OFF-WHITE FINISH, MIN. 20-DEGREE TURN DOWN VANES, MOUNTING GASKET	HART & COOLEY LIMA J&J REGISTER
<u>WH-1</u>	WATER HEATER	40 GAL.; GAS FIRED GLASS LINED TANK	A.O. SMITH RUDD STATE

<u>GENERA</u>	L MECHANICAL NOTES
1.	HEATING SYSTEM SHOWN IS SCHEMATIC AND SOME MINOR ADJUSTMENTS TO THE DUCTWORK AND EQUIPMENT WILL BE MADE DURING INSTALATION. COORDINATE ALL WORK WITH OTHER TRADES THROUGH THE GENERAL CONTRACTOR AND NOTIFY THE ARCHITECT OF ANY MAJOR INSTALLATION CHANGES OR IF STRUCTURAL MEMBERS ARE OBSTRUCTING DUCT RUNS.
2.	HEATING CONTRACTOR SHALL BE RESPONSIBLE FOR BALANCING THE SYSTEM AFTER INSTALLATION AND UPON TURN-OVER TO THE OWNER. REMOVE, CLEAN AND REPLACE WASHABLE FILTERS IN ALL EQUIPMENT.
3.	ELECTRICAL CHARACTERISTICS OF ALL EQUIPMENT SHALL BE PROVIDED TO THE ELECTRICAL CONTRACTOR IN A TIMELY MANNER SO THAT HOOKUPS MAY BE MADE WITHOUT DELAY TO THE PROGRESS OF THE JOB.
4.	HVAC CONTRACTOR SHALL NOT CUT OR DRILL THROUGH ANY STRUCTURAL MEMBER OR ELEMENT WITHOUT CONTACTING THE ARCHITECT FOR APPROVAL AND REQUIREMENTS.
5.	HEATING CONTRACTOR SHALL EXERCISE CARE IN LAYOUT OF FURNACE ROOM. BASED ON DIMENSIONAL CHARACTERISTICS OF EQUIPMENT PURCHASED TO INSURE ACCESSIBILITY TO SERVICE AREAS OF EQUIPMENT.
6.	FURNISH FURNACE MANUFACTURER'S STANDARD THERMOSTAT WITH "HEAT/COOL" AND "FAN/OFF/AUTO" SWITCHING SUB-BASE. WIRE COMPLETE.
7.	CRAWL SPACE SHALL BE MECHANICALLY VENTILATED. PER CODE PROVIDE SUPPLY AND RTURN AIR DUCTS AS REQUIRED TO CONDITION THIS SPACE AS IF IT WERE A BASEMENT.

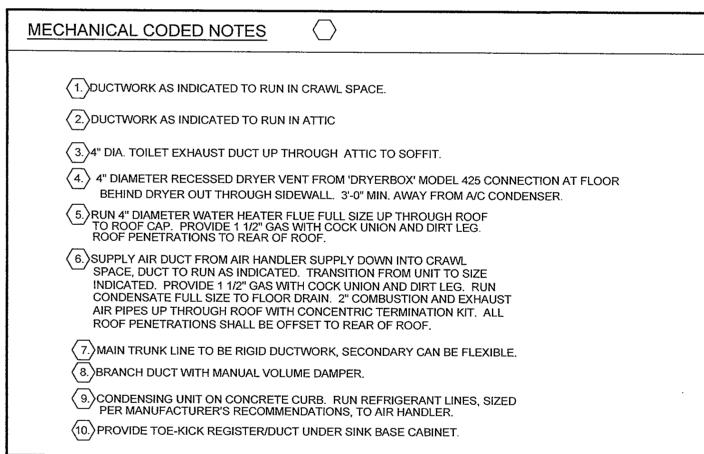

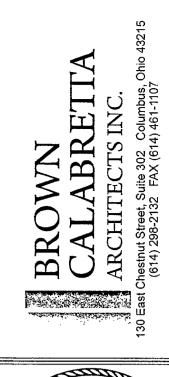

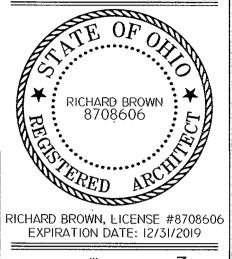

service shall remain the property of the Architect. Bro Calabretta Architects Inc. The Architect shall retain all common law, statutory and other reserved rights, including the copyright thereto.

| PRELIM DESIGN | PRELIM CONSTRUCTION SET | BID/PERMIT SUBMITTAL SET | BID/PERMIT SUBMITTAL SET | AS.R.III T SET |

OHIO LIVING
VINEYARD ON CATAWBA
Meredith Beck

===		 	 	 	_
REVISION	NEW LOT & RESIDENT CHANGES				
DATE	6/3/19				
NO.	7				

JOB NO: 9502.1

DATE: 4/30/19

DRAWN: dcp

CHECKED: rbb


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DRAWING NAME :

MECHANICAL

12 of 13

M-1

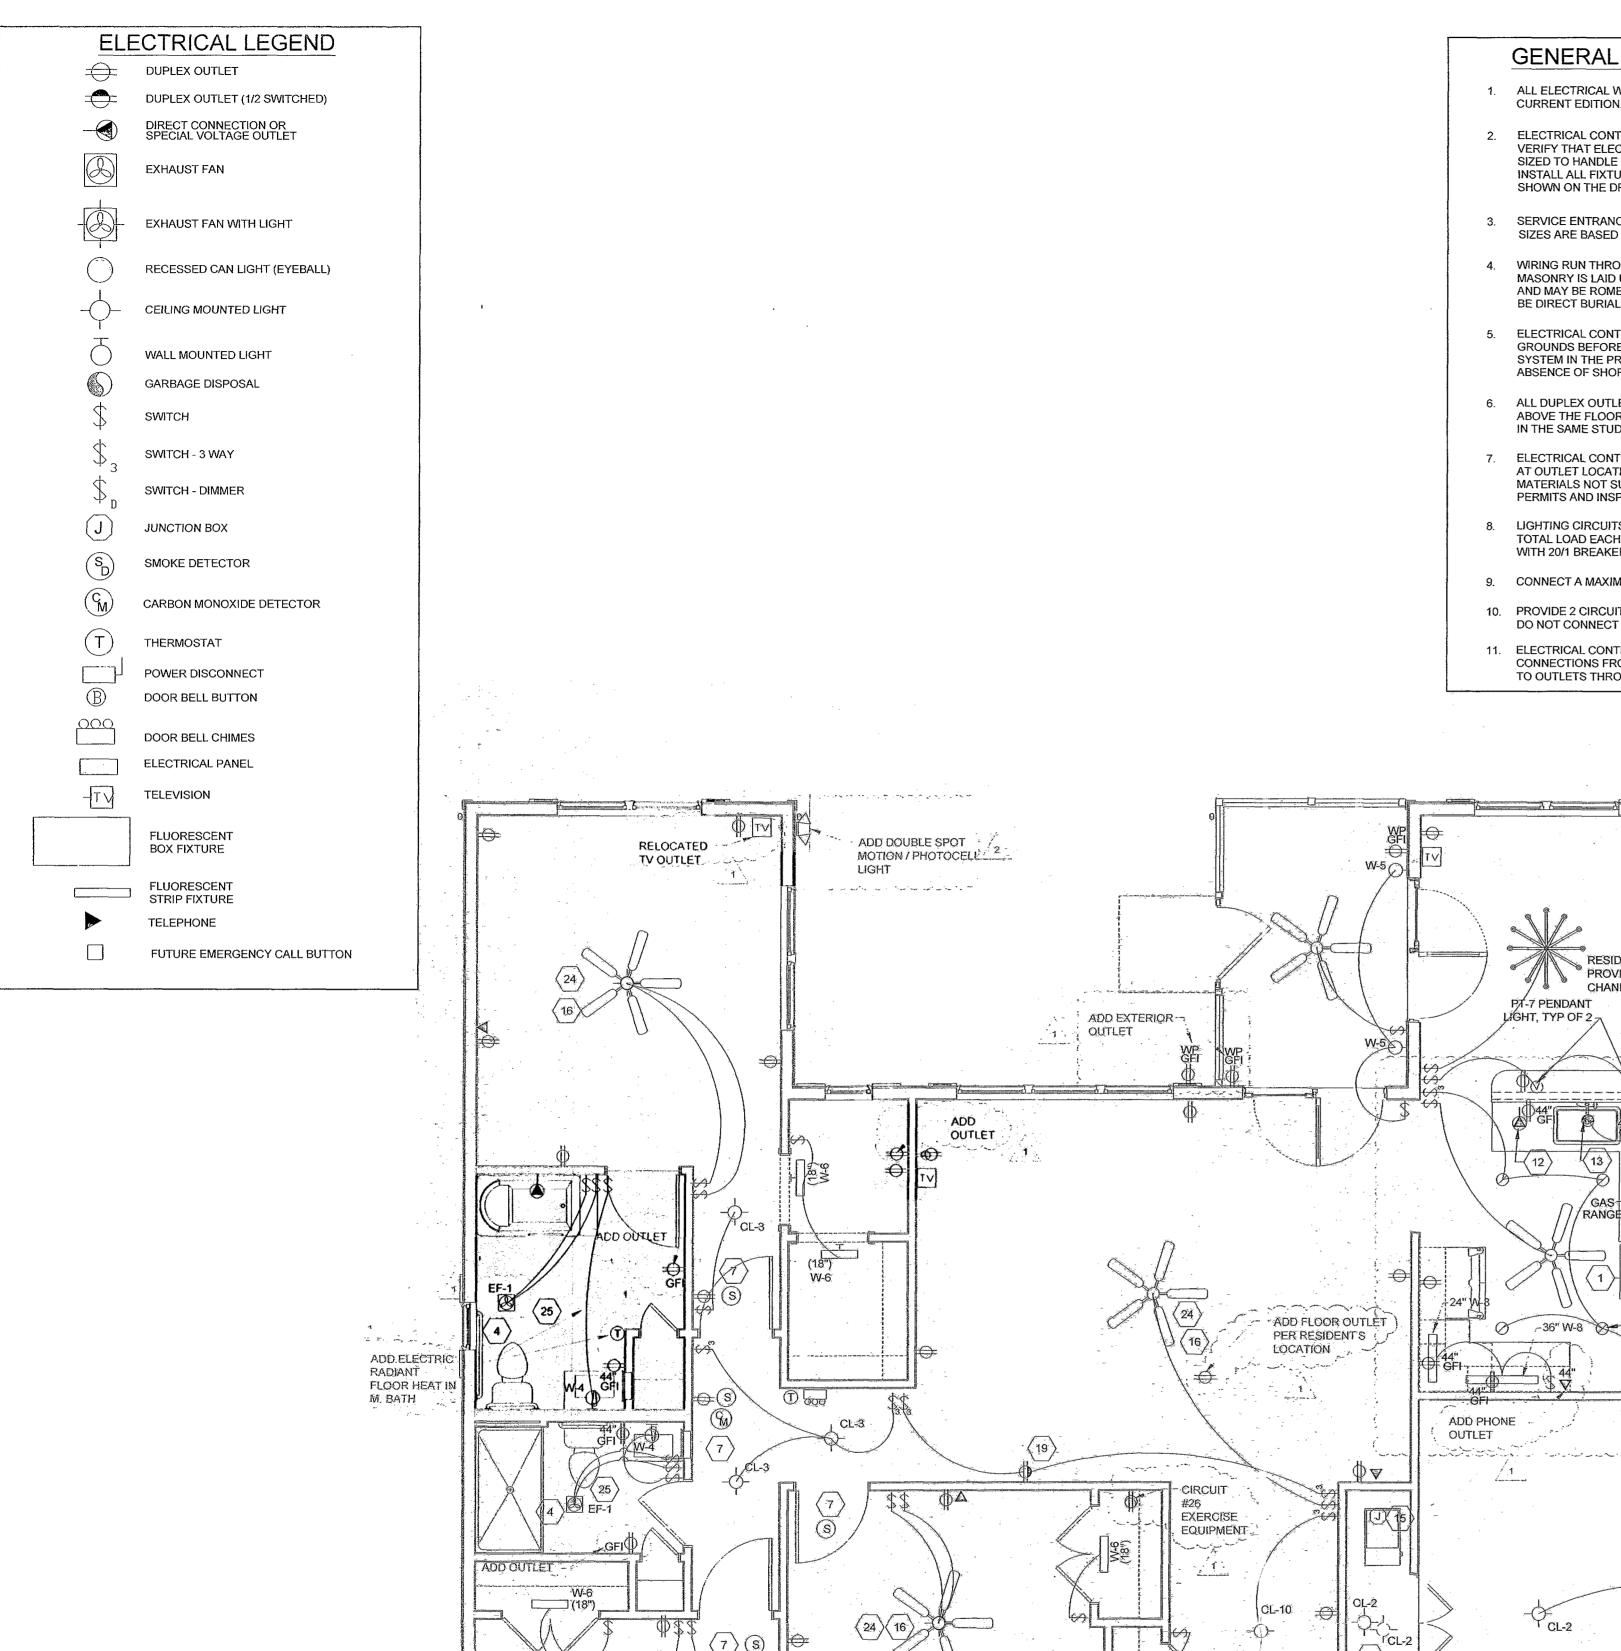

ADD TV & PHONE OUTLETS

ELECTRICAL PLAN

PHONE -OUTLETS GENERAL ELECTRICAL NOTES

1. ALL ELECTRICAL WORK SHALL CONFORM TO THE NATIONAL ELECTRIC CODE CURRENT EDITION.

2. ELECTRICAL CONTRACTOR SHALL TABULATE LOADS FROM ALL NEW WORK, AND VERIFY THAT ELECTTRIC SERVICE PANEL BREAKERS, AND WIRE ARE PROPERLY SIZED TO HANDLE LOADS ELECTRICAL CONTRACTOR SHALL SUPPLY AND INSTALL ALL FIXTURES, JUNCTION BOXES, OUTLETS, SWITCHES, AND WIRING SHOWN ON THE DRAWINGS AND NEEDED FOR A COMPLETE JOB.

3. SERVICE ENTRANCE CABLE SIZE ARE BASED ON ALUMINUM, ALL OTHER WIRE SIZES ARE BASED ON COPPER.

4. WIRING RUN THROUGH MASONRY SHALL BE IN CONDUIT, INSTALLED AS THE MASONRY IS LAID UP. WIRING MAY RUN IN THE WALL INSULATION SPACE AND MAY BE ROMEX TYPE IF APPROVED BY CODE. UNDERGROUND WIRING SHALL BE DIRECT BURIAL TYPE.

5. ELECTRICAL CONTRACTOR SHALL TEST ALL WIRING FOR CONTINUITY AND GROUNDS BEFORE FIXTURE INSTALLATION AND SHALL THEN TEST THE ENTIRE SYSTEM IN THE PRESENCE OF THE OWNER UPON COMPLETION TO INCUR THE ABSENCE OF SHORT CIRCUITS AND GROUNDS.

6. ALL DUPLEX OUTLETS AND COMMUNICATION JUNCTION BOXES SHALL BE AT 18" ABOVE THE FLOOR UNLESS NOTED OTHERWISE OUTLETS SHALL NOT BE LOCATED IN THE SAME STUD SPACE ON OPPOSITE SIDES OF A COMMON WALL.

7. ELECTRICAL CONTRACTOR SHALL COORDINATE CABLE TV SYSTEM INSTALLATION AT OUTLET LOCATIONS SHOWN ON PLANS AND PROVIDE ALL LABOR AND MATERIALS NOT SUPPLIED BY THE RESPECTIVE COMPANIES, BUT NEEDED FOR ALL PERMITS AND INSPECTIONS REQUIRED FOR ELECTRICAL WORK.

8. LIGHTING CIRCUITS SHALL HAVE NO MORE THAN 1500 WATTS OF TOTAL LOAD EACH LIGHTING CIRCUIT SHALL BE MINIMUM #12 WIRE

9. CONNECT A MAXIMUM OF 6 CONVENIENCE OUTLETS TO A CIRCUIT.

10. PROVIDE 2 CIRCUITS FOR RECEPTACLES ABOVE COUNTER IN KITCHEN DO NOT CONNECT OTHER LOADS TO THESE CIRCUITS.

11. ELECTRICAL CONTRACTOR IS RESPONSIBLE FOR RUNNING COAXIAL CABLE CONNECTIONS FROM THE CLOSEST CABLE PEDESTAL TO THE HOUSE AND WIRE

A/C CONDENSER DISCONNECT BOX

W-5

TO OUTLETS THROUGHOUT THE HOUSE

CL-2 5

RESIDENT PROVIDED CHANDELIER


VOL 70 PG 13

PANEL NO.	125	AMP.		2)		_ A.I.C.	TRIM:	: F	LUSH []	SURFAC
P-1	120/240 FED FROM_M	VOLT.	<u>1</u> L00				W/GROUND BUS W/SOLID NEUTRAL W/MAIN CIRCUIT BREAKER			
TYPE: SQUARE D LOAD CENTER	* GFI BREAKER ** WITH "LOCK-ON" W/MAIN LUGS ONLY									
LOAD		WIRE SIZE	CB/P	CIR. NO.		CIR. NO.	CB/P	WIRE SIZE	LOAD	
DRYER		10	30/2	3	•	2	50/2	6	RANGE	
WASHER		12	20/1	5		6	20/1	-	RANGE HD./RECEPT.	-
GARAGE		12	20/1	7	lack	8	20/1	12	REFRIGERATOR	
LIGHTING - BEDROOF & BATH AREA		12	20/1	9		10	20/1	12	DISPOSAL	
LIGHTING - LIVING RI KITCHEN & DINING	И.,	12	20/1			12	20/1	-	SPARE / MICROWAVE	
RECEPTACLES		12	15/1	13		14	20/1	12	KITCHEN RECEPT.	
RECEPTACLES		12	15/1	15		16	20/1	12	KITCHEN RECEPT.	
RECEPTACLES		12	15/1	17		18	15/1	12	EXTERIOR LIGHTS/REC.	
RECEPTACLES		12	15/1	19	•	20	15/1	12	SMOKE DETECTORS **	- · · ·
BATHROOM RECEPTA	ACLES	12	20/1	21		22	20/1	12	DISHWASHER	
BATHROOM RECEPTA	ACLES	12	20/1	23		24	20/1	12	WALK IN TUB (1)	
AHU-1		12	20/1	25	lack b	26	20/1	12	EXERCISE EQUIPMENT	1
COND-1				27	$ \ \ $	28	-	-	SPACE	
COND-1		1 1	12	29		30	-	-	SPACE	

PROVIDE BREAKER SIZE PER EQUIPMENT MANUFACTURER'S REQUIREMENTS. WIRE SIZE TO BE PER N.E.C. FOR OVERCURRENT PROTECTION (TABLE 310-16).

(2) ELECTRICAL CONTRACTOR TO VERIFY WITH POWER COMPANY.

LIGH	HTING FIXTURE S	CHEDULE			
TYPE	MANUFACTURER	CATALOG NUMBER	MOUNTING	LAMPS	REMARKS
CL-1	PROGRESS	P7275-30	CEILING	4-F34T12	WHITE WOOD TRIMMED BOX LIGHT
CL-2	ANY	PORCELAIN SOCKET	VARIES	1-75W	PROVIDE PULL-CHAIN AS REQUIRED
CL-3	PROGRESS	P-3817-09EB	CEILING	2-13W CFL	BRUSHED NICKEL
W-4	PROGRESS	P3035-09	WALL	3-100W	BRUSHED NICKEL
W-5	PROGRESS	P5826-31	WALL	1-60W	BLACK FINISH, CLEAR LENS
W-6	LITHONIA	FMMCL 840 S1 (18")	CEILING/WALL	LED	WIRED TO WALL SWITCH
P-7	PROGRESS	P5170-09	PENDANT	MEDIUM BASE LED BULB	CYLINDER PENDANT - BOTTOM OF SHADE AT 6'-0" AFF
W-8	PROGRESS	P7012-30 P7005-30 P7013-30	UNDERCABINET UNDERCABINET UNDERCABINET	LED LED LED	12" 18" 24"
R-9	PROGRESS	P821-AT/P8063-28	RECESSED CAN	MED. BASE LED	6" INCANDESCENT HOUSING W/ WHITE TRIM
CL-10	PROGRESS	P3818-09EB	CEILING	3-13W CFL	BRUSHED NICKEL
PM-11	PROGRESS	P5482-31 w\ P5391.3PC	POLE MOUNTED	1-GU24 18 W	BLACK FINISH, PHOTO CELL CONTROL
S	SMOKE DETECTOR NU #S-230 HONEYWELL # D1002 SQUARE D #EG 769 AC FAREX FX 1218	TC49 D-41 BRK	CEILING		SMOKE DETECTORS SHALL BE INTERCONNECTED SO WHEN ONE IS ACTIVATED, ALL SOUND ALARM.
EF-1	NUTONE 70 CFM FLUORESCENT FAN/LIGHT	769RL	CEILING	1-100w	OUTSIDE EXHAUST TO BE PROVIDED BY MECHANICAL CONTRACTOR
EF-2	NUTONE 1500 WATT HEATER 100 CFM FAN/LIGHT	765HL	CEILING	1-100w	OUTSIDE EXHAUST TO BE PROVIDED BY MECHANICAL CONTRACTOR

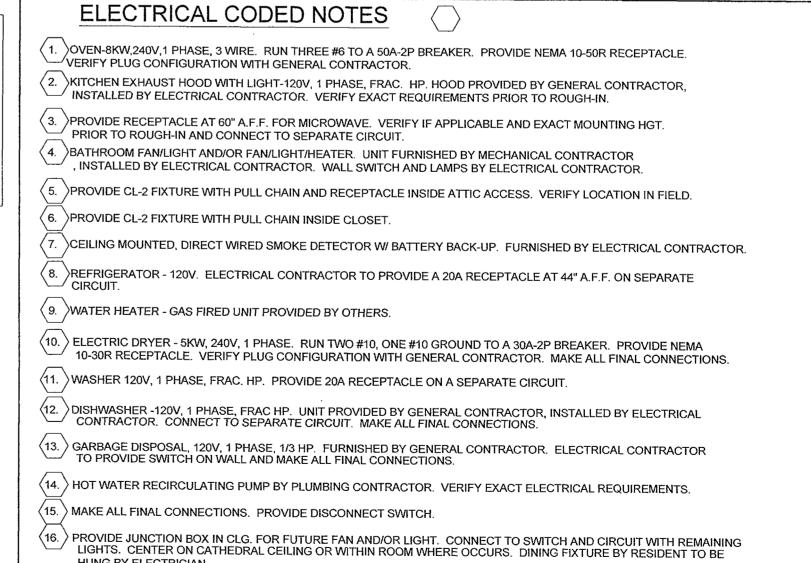

HUNG BY ELECTRICIAN.

(17.) DEVICE LOCATION MAY VARY DEPENDING UPON OPTIONAL FIREPLACE. VERIFY EXACT LOCATION IN FIELD.

(18.) PROVIDE JUNCTION BOX FOR GARAGE DOOR OPENER. INSTALL PER MANUFACTURER'S RECOMMENDATIONS. UNIT

FURNISHED BY GENERAL CONTRACTOR. VERIFY ELECTRICAL REQUIREMENTS PRIOR TO ROUGH-IN. (19.) CONNECT 1/2 OF DUPLEX TO WALL SWITCH.

(20.) PROVIDE CL-2 FIXTURE WITH PULL CHAIN INSIDE CRAWL SPACE ACCESS. VERIFY LOCATION IN FIELD.

(21.) VERIFY REQUIREMENTS WITH EQUIPMENT SUPPLIER. PROVIDE ALL SWITCHES, WIRING, CONNECTIONS AS REQUIRED.

(22. PROVIDE "SMARTVENT" HUMIDISTATICALLY CONTROLLED CRAWL SPACE VENTILATION. PROVIDE ELECTRICAL CONNECTION.

23. OMITTED

(24.) REINFORCE JUNCTION BOX AS REQUIRED TO ALLOW FOR FUTURE INSTALLATION OF PADDLE FAN

(25.) DEDICATED CIRCUIT FOR EACH BATHROOM RECEPTACLE.

RICHARD BROWN RICHARD BROWN, LICENSE #8708606 EXPIRATION DATE: 12/31/2019 HIO LIVING VINEYARD ᆼ JOB NO: 9502.1 DATE: 4/30/19 DRAWN: dcp CHECKED: rbb FILE NAME : DRAWING NAME: **ELECTRICAL**

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